General Notes

N

All work to be in compliance with the current residential standards of the National Building Code of Canada, current electrical and plumbing codes and all local building code and bylaws which may take precedence

Pool

Lot 6

All work shall be performed in all respects to good building practice Written dimensions to be followed. Do not scale from the drawings

Building location to be verified by surveyor prior to construction.
Foundations to be poured on undisturbed engineered building pad. All measurements, grades and levels to be verified on site before commencing construction


- Framing and Foundations
 All dimensions to face of stud unless otherwise noted. • All headers, beams, columns and supporting foundations to be confirmed
- by the roof truss and floor system supplier.
- Roof truss and floor joist layout will be provided by the manufacturer
 All suspended slabs and foundations walls over 8' must be designed
- and/or approved by a professional engineer.
 All standard foundations to conform with engineering, soil conditions and
- best practices. • All concrete to have a minimum compressive strength of 20mpa at 28
- days. Do not backfill tall foundations until floor structure is complete. • Any roof truss web configurations shown are for representation only.
- Engineered drawings of each truss will be supplied by the truss supplier.
 All joists spans more than 7'-0 shall be bridged at mid span using 2x2
- diagonal bridging installed as per N.B.C.
 Flashing to be installed at all penetrations in roof system and changes in
- roof plane.
- Flashing to be installed at all changes in horizontal exterior finishes and over all unprotected openings. Caulking to be installed around all unflashed exterior openings

<u>Thermal Performance</u> • All new construction must conform to BCBC 9.36 thermal performance codes


- <u>Plumbing, Electrical and Mechanical Systems</u>
 All plumbing to be designed and installed per current plumbing codes and by a qualified plumber.
- Confirm layouts and dimensions with suppliers of all kitchens, bars, washrooms, laundry rooms, utility rooms, in-floor heating, etc.
- All fixtures to be approved by the owner
 Heating and venting calculations and system design by engineer, supplier or qualified installer.
- Electrical system to be designed and installed by qualified electrician
- <u>Local Bylaws and Development Regulations</u>
 All construction will be within local bylaw requirements. These include design restrictions, height restrictions, frost coverage, water run off containment, water consumption, landscaping, etc. • Any changes required to these designs should be reported to Meyer
- Designs Perimeter drainage shall be installed where required by local authorities having jurisdiction and to their approval


Meyer Designs shall not be responsible for any variances from the structural drawings and specifications, or adjustments required resulting from conditions encountered at the job site, and is the sole responsibility of the owner and contractor

Meyer Designs makes every effort to provide complete and accurate construction drawings. However, we assume no liability for errors or omissions which may affect construction. It is the responsibility of all trades and sub trades to check and verify all dimensions and details before commencing with their portion of the construction. Should any discrepancies be found on these plans please advise Meyer Designs so the necessary corrections can be made.

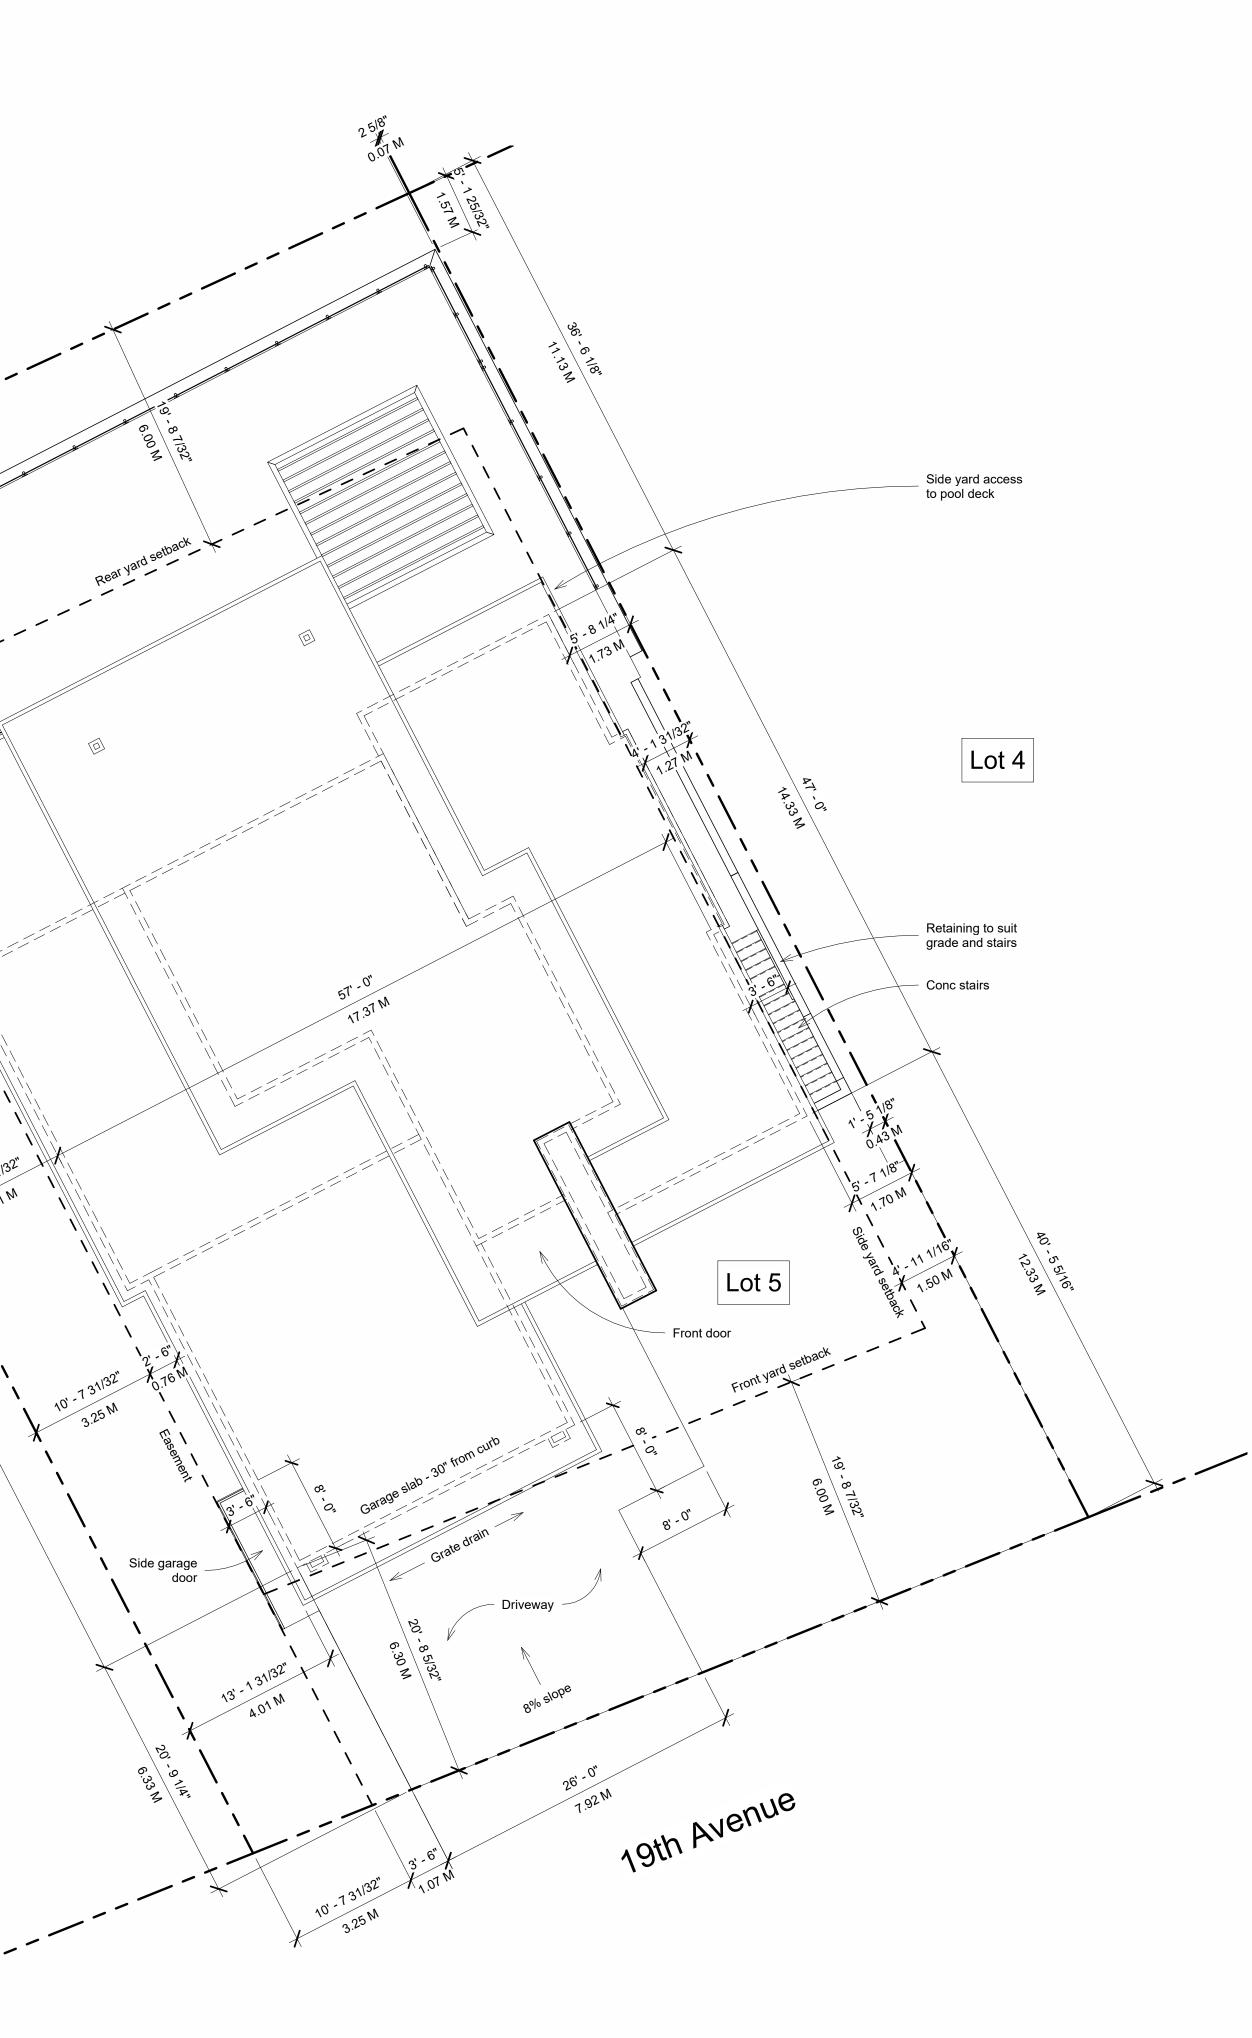

1 <u>Site Plan</u> 1/8" = 1'-0"

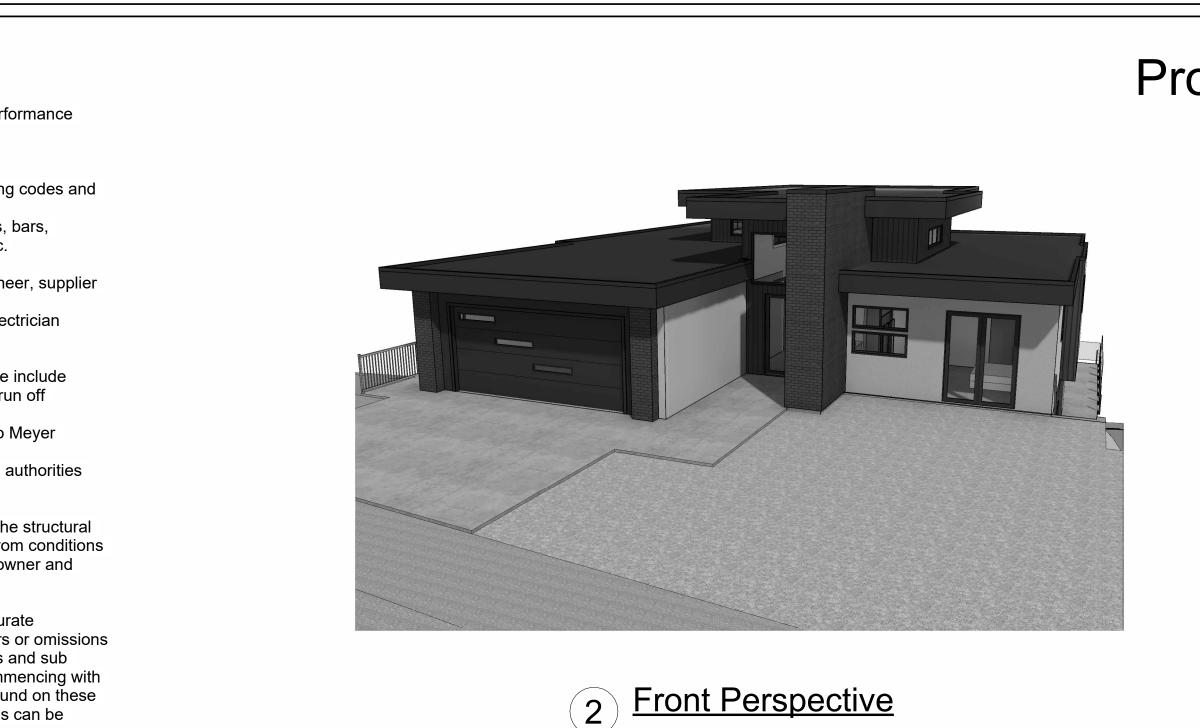


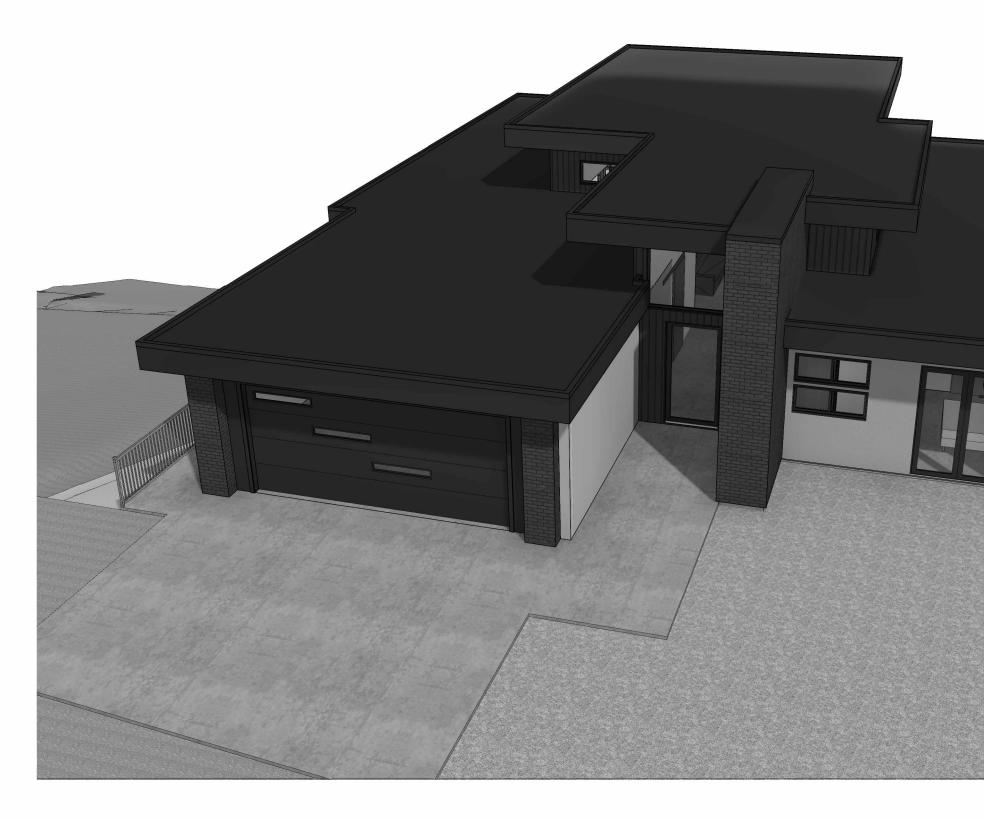


6 Front Perspective - Birds Eye



Proposed Residence for Sharon LeClair

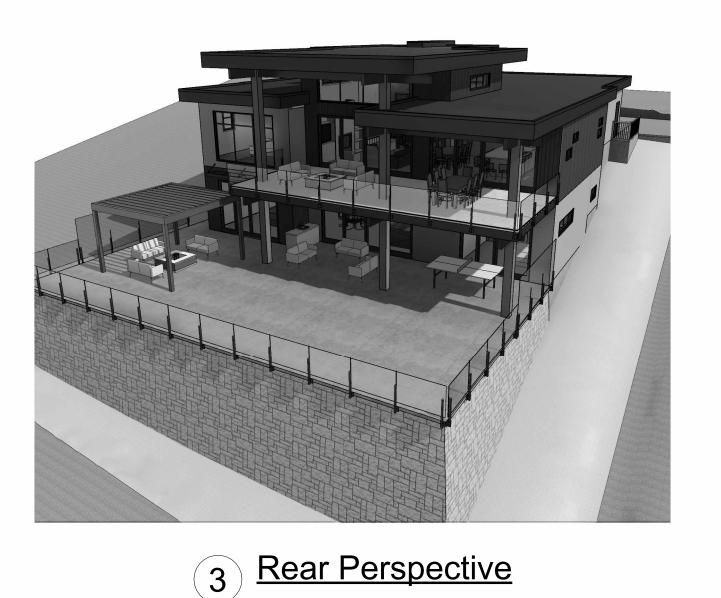

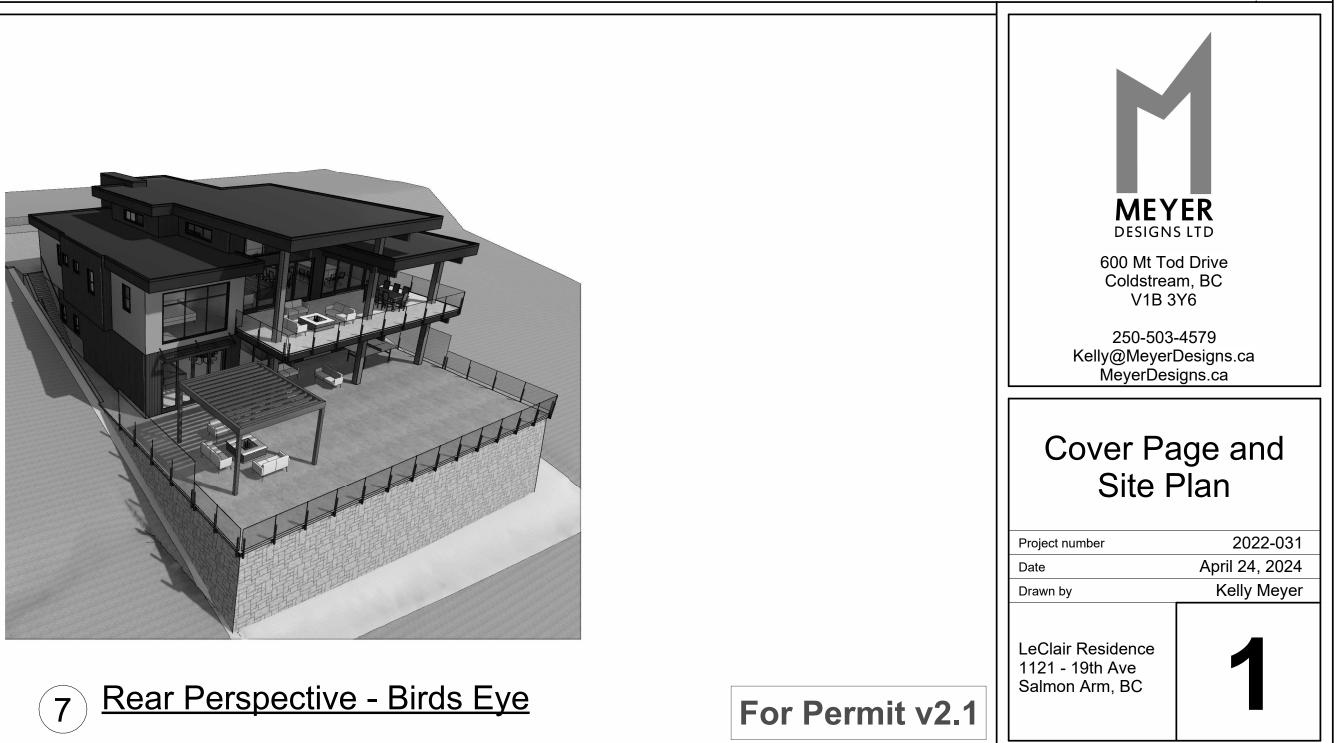

Drawing Index		
Drawing Number	Drawing Name	
1	Cover Page and Site Plan	
2	Foundation and Lower Floor Plans	
3	Main Floor Plan	
4	Elevations and Perspectives	
5	Sections and Details	
6	Sections, Roof Plan and Details	

Legal Address Lot 5 Byersview

Civic Address

1121 19th Avenue Salmon Arm, BC

Zoning

Single Family Side yard setback R1 1.5m 6.0m 6.0m 10.0m 40% 0.65


Front yard setback Rear yard setback Max height Coverage Floor area ratio

Site Coverage

(Measured in square feet)	
Lot	9135
House (main floor) Garage Deck Total Coverage	2182 698 629 3509 38.4%


Floor Area Ratio

(Measured in square feet) 9135 2182 2140 632 4954 0.54 House (main floor) House (Indin licer) House (lower floor) Deck (main floor) Total Floor area ratio

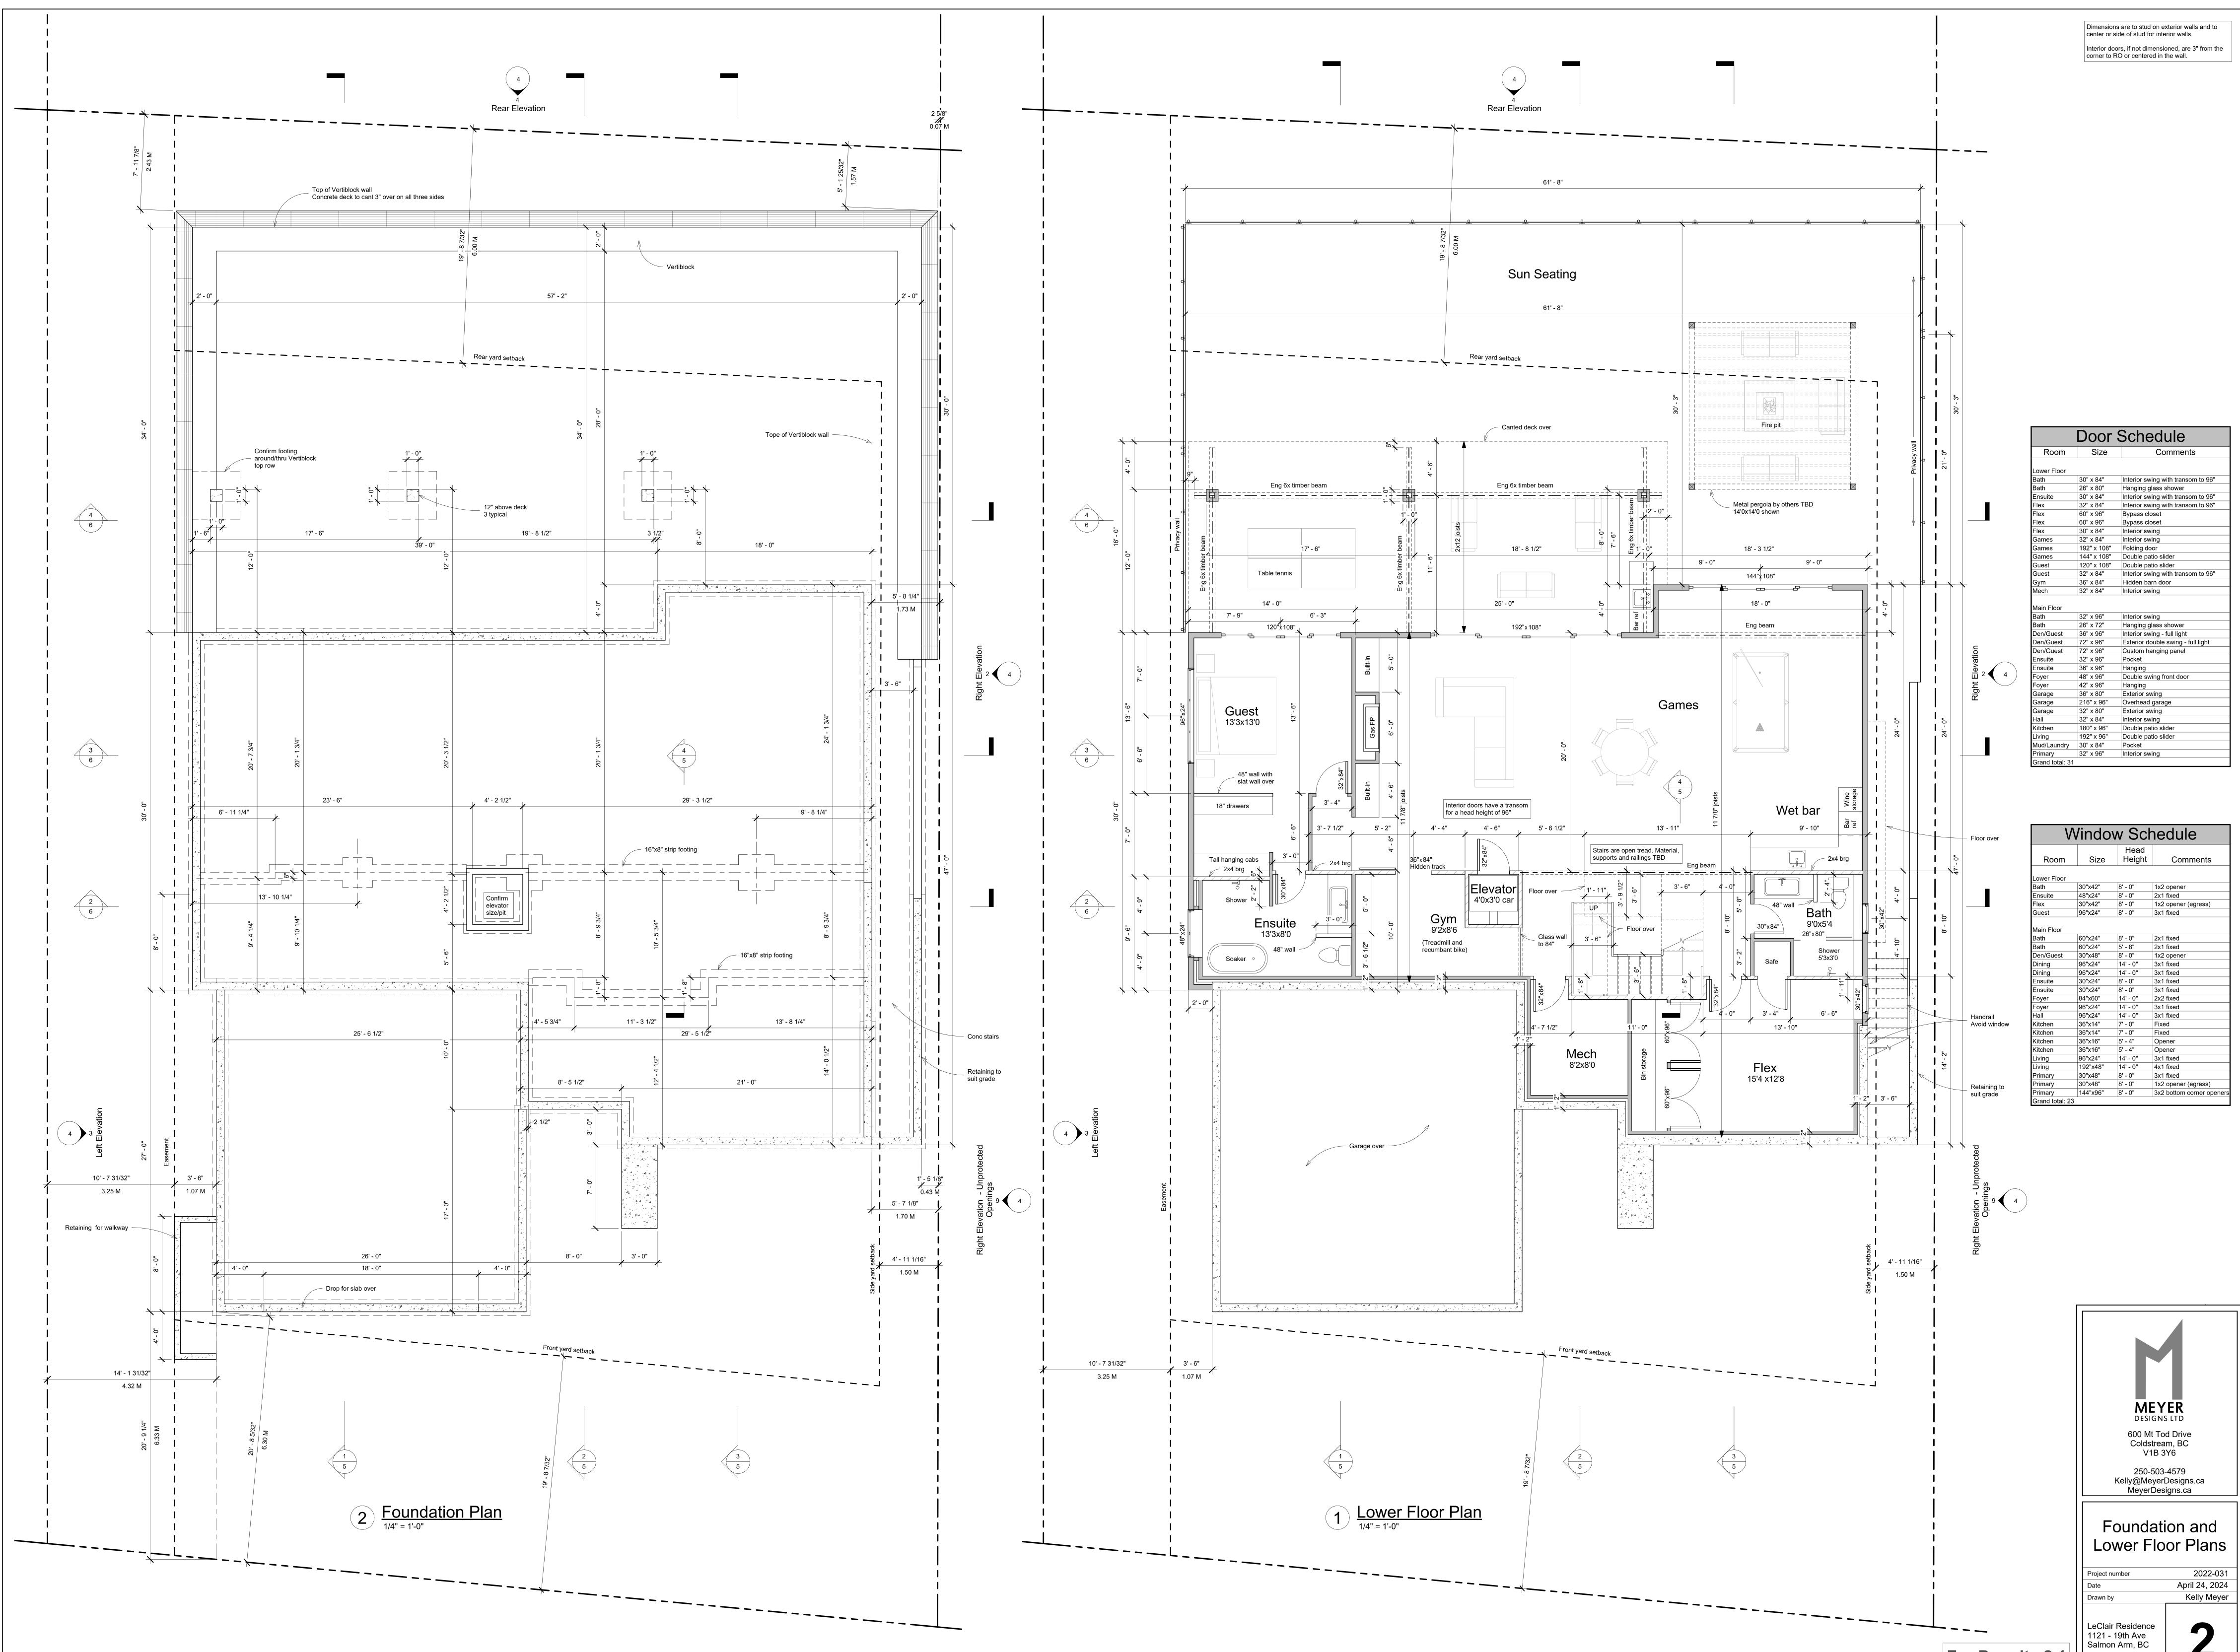

Door Schedule			
Room	Size	Comments	
Lower Floor			
Bath	30" x 84"	Interior swing with transom to 96"	
Bath	26" x 80"	Hanging glass shower	
Ensuite	30" x 84"	Interior swing with transom to 96"	
Flex	32" x 84"	Interior swing with transom to 96"	
Flex	60" x 96"	Bypass closet	
Flex	60" x 96"	Bypass closet	
Flex	30" x 84"	Interior swing	
Games	32" x 84"	Interior swing	
Games	192" x 108"	Folding door	
Games	144" x 108"	Double patio slider	
Guest	120" x 108"	Double patio slider	
Guest	32" x 84"	Interior swing with transom to 96"	
Gym	36" x 84"	Hidden barn door	
Mech	32" x 84"	Interior swing	
Main Floor			
Bath	32" x 96"	Interior swing	
Bath	26" x 72"	Hanging glass shower	
Den/Guest	36" x 96"	Interior swing - full light	
Den/Guest	72" x 96"	Exterior double swing - full light	
Den/Guest	72" x 96"	Custom hanging panel	
Ensuite	32" x 96"	Pocket	
Ensuite	36" x 96"	Hanging	
Foyer	48" x 96"	Double swing front door	
Foyer	42" x 96"	Hanging	
Garage	36" x 80"	Exterior swing	
Garage	216" x 96"	Overhead garage	
Garage	32" x 80"	Exterior swing	
Hall	32" x 84"	Interior swing	
Kitchen	180" x 96"	Double patio slider	
Living	192" x 96"	Double patio slider	
Mud/Laundry	30" x 84"	Pocket	
Primary	32" x 96"	Interior swing	

Window Schedule			
Room	Size	Head Height	Comments
			1
Lower Floor	0.011 (.011		4.0
Bath	30"x42"	8' - 0"	1x2 opener
Ensuite	48"x24"	8' - 0"	2x1 fixed
Flex	30"x42"	8' - 0"	1x2 opener (egress)
Guest	96"x24"	8' - 0"	3x1 fixed
Main Floor			
Bath	60"x24"	8' - 0"	2x1 fixed
Bath	60"x24"	5' - 8"	2x1 fixed
Den/Guest	30"x48"	8' - 0"	1x2 opener
Dining	96"x24"	14' - 0"	3x1 fixed
Dining	96"x24"	14' - 0"	3x1 fixed
Ensuite	30"x24"	8' - 0"	3x1 fixed
Ensuite	30"x24"	8' - 0"	3x1 fixed
Foyer	84"x60"	14' - 0"	2x2 fixed
Foyer	96"x24"	14' - 0"	3x1 fixed
Hall	96"x24"	14' - 0"	3x1 fixed
Kitchen	36"x14"	7' - 0"	Fixed
Kitchen	36"x14"	7' - 0"	Fixed
Kitchen	36"x16"	5' - 4"	Opener
Kitchen	36"x16"	5' - 4"	Opener
Living	96"x24"	14' - 0"	3x1 fixed
Living	192"x48"	14' - 0"	4x1 fixed
Primary	30"x48"	8' - 0"	3x1 fixed
Primary	30"x48"	8' - 0"	1x2 opener (egress)
Primary	144"x96"	8' - 0"	3x2 bottom corner opene
Grand total: 2	3	- 1	•

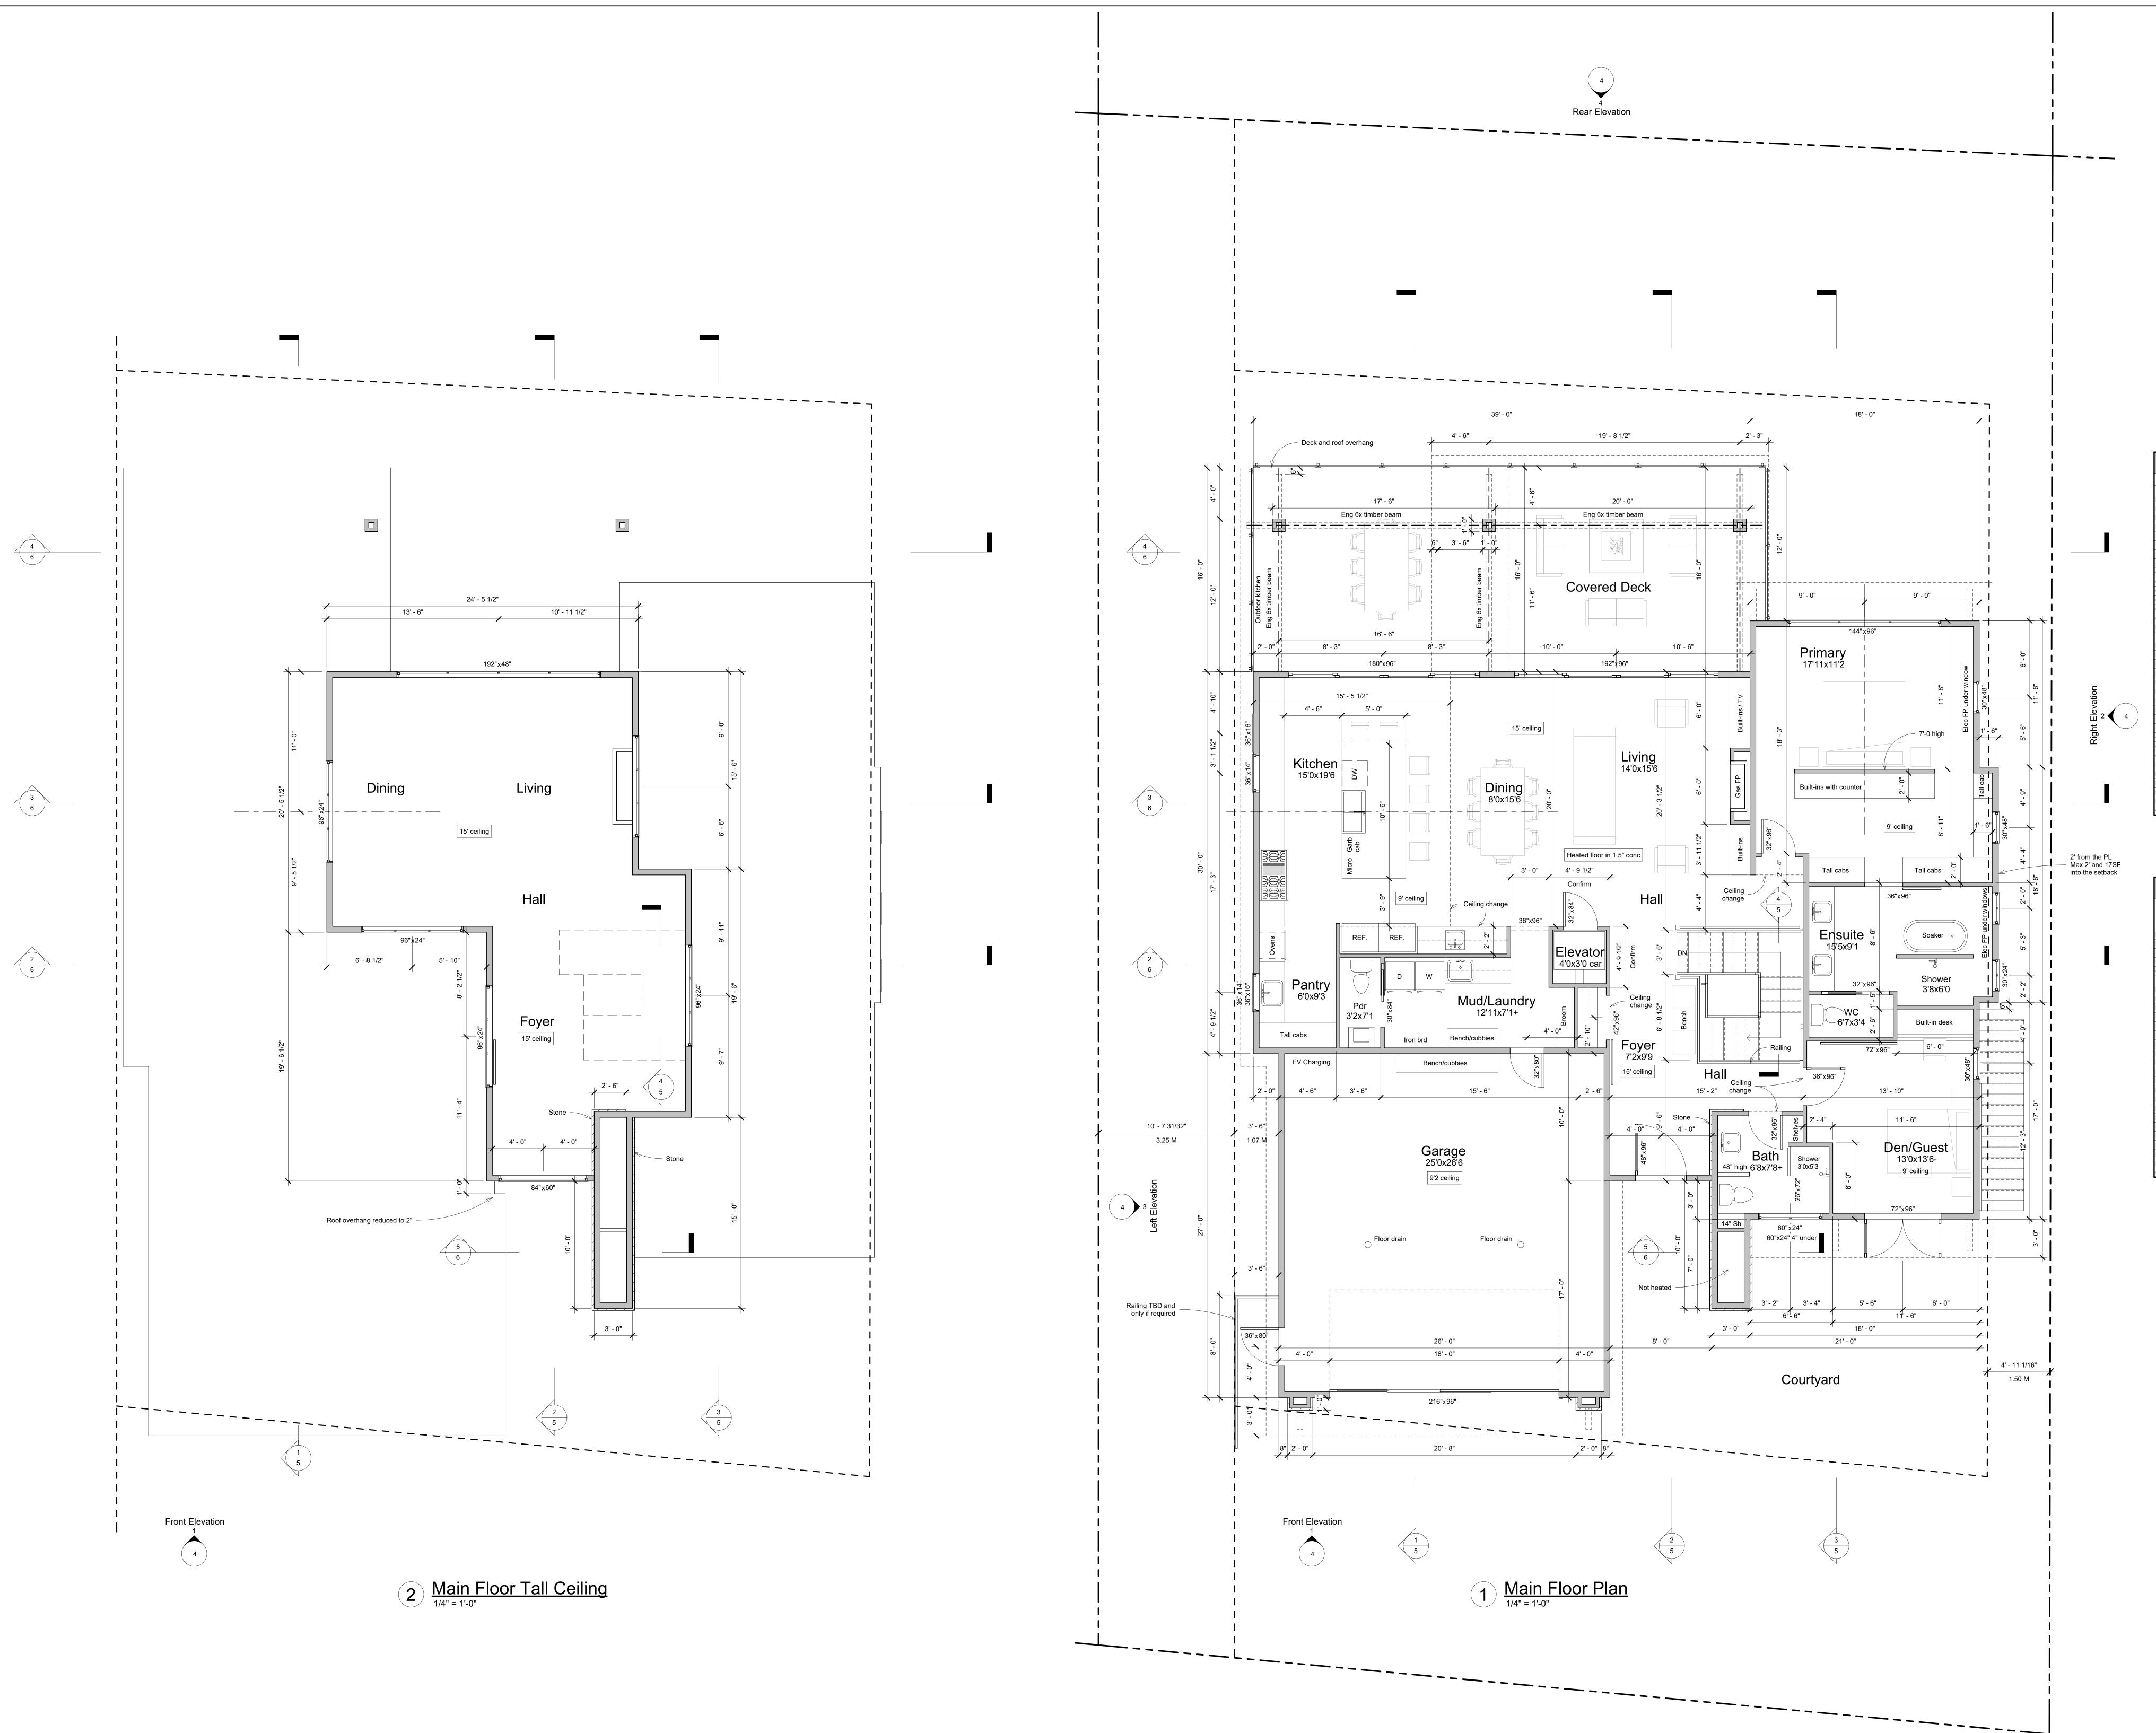


Room	Size	Comments	
rtoonn	0.20	Commonie	
_ower Floor			
Bath	30" x 84"	Interior swing with transom to 96"	
Bath	26" x 80"	Hanging glass shower	
Ensuite	30" x 84"	Interior swing with transom to 96"	
Flex	32" x 84"	Interior swing with transom to 96'	
Flex	60" x 96"	Bypass closet	
Flex	60" x 96"	Bypass closet	
Flex	30" x 84"	Interior swing	
Games	32" x 84"	Interior swing	
Games	192" x 108"	Folding door	
Games	144" x 108"	Double patio slider	
Guest	120" x 108"	Double patio slider	
Guest	32" x 84"	Interior swing with transom to 96'	
Gym	36" x 84"	Hidden barn door	
Mech	32" x 84"	Interior swing	
Main Floor			
Bath Bath	32" x 96"	Interior swing	
Bath	26" x 72"	Hanging glass shower	
Den/Guest	36" x 96" 72" x 96"	Interior swing - full light	
Den/Guest	72 x 96 72" x 96"	Exterior double swing - full light	
Den/Guest Ensuite	32" x 96"	Custom hanging panel	
Ensuite	32 x 96 36" x 96"	Pocket	
Enquito	100 X 90	Hanging	
Ensuite Eover			
Foyer	48" x 96"	Double swing front door	
Foyer Foyer	48" x 96" 42" x 96"	Double swing front door Hanging	
Foyer Foyer Garage	48" x 96" 42" x 96" 36" x 80"	Double swing front door Hanging Exterior swing	
Foyer Foyer Garage Garage	48" x 96" 42" x 96" 36" x 80" 216" x 96"	Double swing front doorHangingExterior swingOverhead garage	
Foyer Foyer Garage Garage Garage	48" x 96" 42" x 96" 36" x 80" 216" x 96" 32" x 80"	Double swing front doorHangingExterior swingOverhead garageExterior swing	
Foyer Foyer Garage Garage Garage Hall	48" x 96" 42" x 96" 36" x 80" 216" x 96" 32" x 80" 32" x 84"	Double swing front doorHangingExterior swingOverhead garageExterior swingInterior swing	
Foyer Foyer Garage Garage Garage Hall Kitchen	48" x 96" 42" x 96" 36" x 80" 216" x 96" 32" x 80" 32" x 84" 180" x 96"	Double swing front doorHangingExterior swingOverhead garageExterior swingInterior swingDouble patio slider	
Foyer Foyer Garage Garage Garage Hall	48" x 96" 42" x 96" 36" x 80" 216" x 96" 32" x 80" 32" x 84"	Double swing front doorHangingExterior swingOverhead garageExterior swingInterior swing	

Window Schedule			
Room	Size	Head Height	Comments
Lower Floor			
Bath	30"x42"	8' - 0"	1x2 opener
Ensuite	48"x24"	8' - 0"	2x1 fixed
Flex	30"x42"	8' - 0"	1x2 opener (egress)
Guest	96"x24"	8' - 0"	3x1 fixed
Main Floor Bath	60"x24"	8' - 0"	2x1 fixed
Bath		5' - 8"	2x1 fixed
Den/Guest	60"x24" 30"x48"	5 - 8 8' - 0"	
	96"x24"		1x2 opener
Dining Dining	96 x24 96"x24"	14' - 0" 14' - 0"	3x1 fixed 3x1 fixed
Dining Ensuite	30"x24"	8' - 0"	3x1 fixed
	30 x24 30"x24"	8' - 0"	3x1 fixed
Ensuite	30 x24 84"x60"	14' - 0"	2x2 fixed
Foyer	96"x24"	14 - 0	3x1 fixed
Foyer Hall	96 x24 96"x24"	14 - 0	3x1 fixed
Kitchen	36"x14"	7' - 0"	Fixed
Kitchen	36 x 14 36"x14"	7'-0	Fixed
Kitchen	36"x14 36"x16"	5' - 4"	Opener
Kitchen	36"x16"	5' - 4"	Opener
	96"x24"	14' - 0"	3x1 fixed
Living	190 x24	14 - 0	4x1 fixed
Living Primary	30"x48"	8' - 0"	3x1 fixed
Primary	30"x48"	8' - 0"	1x2 opener (egress)
Primary	144"x96"	8' - 0"	3x2 bottom corner opene
Grand total: 2		0-0	



J

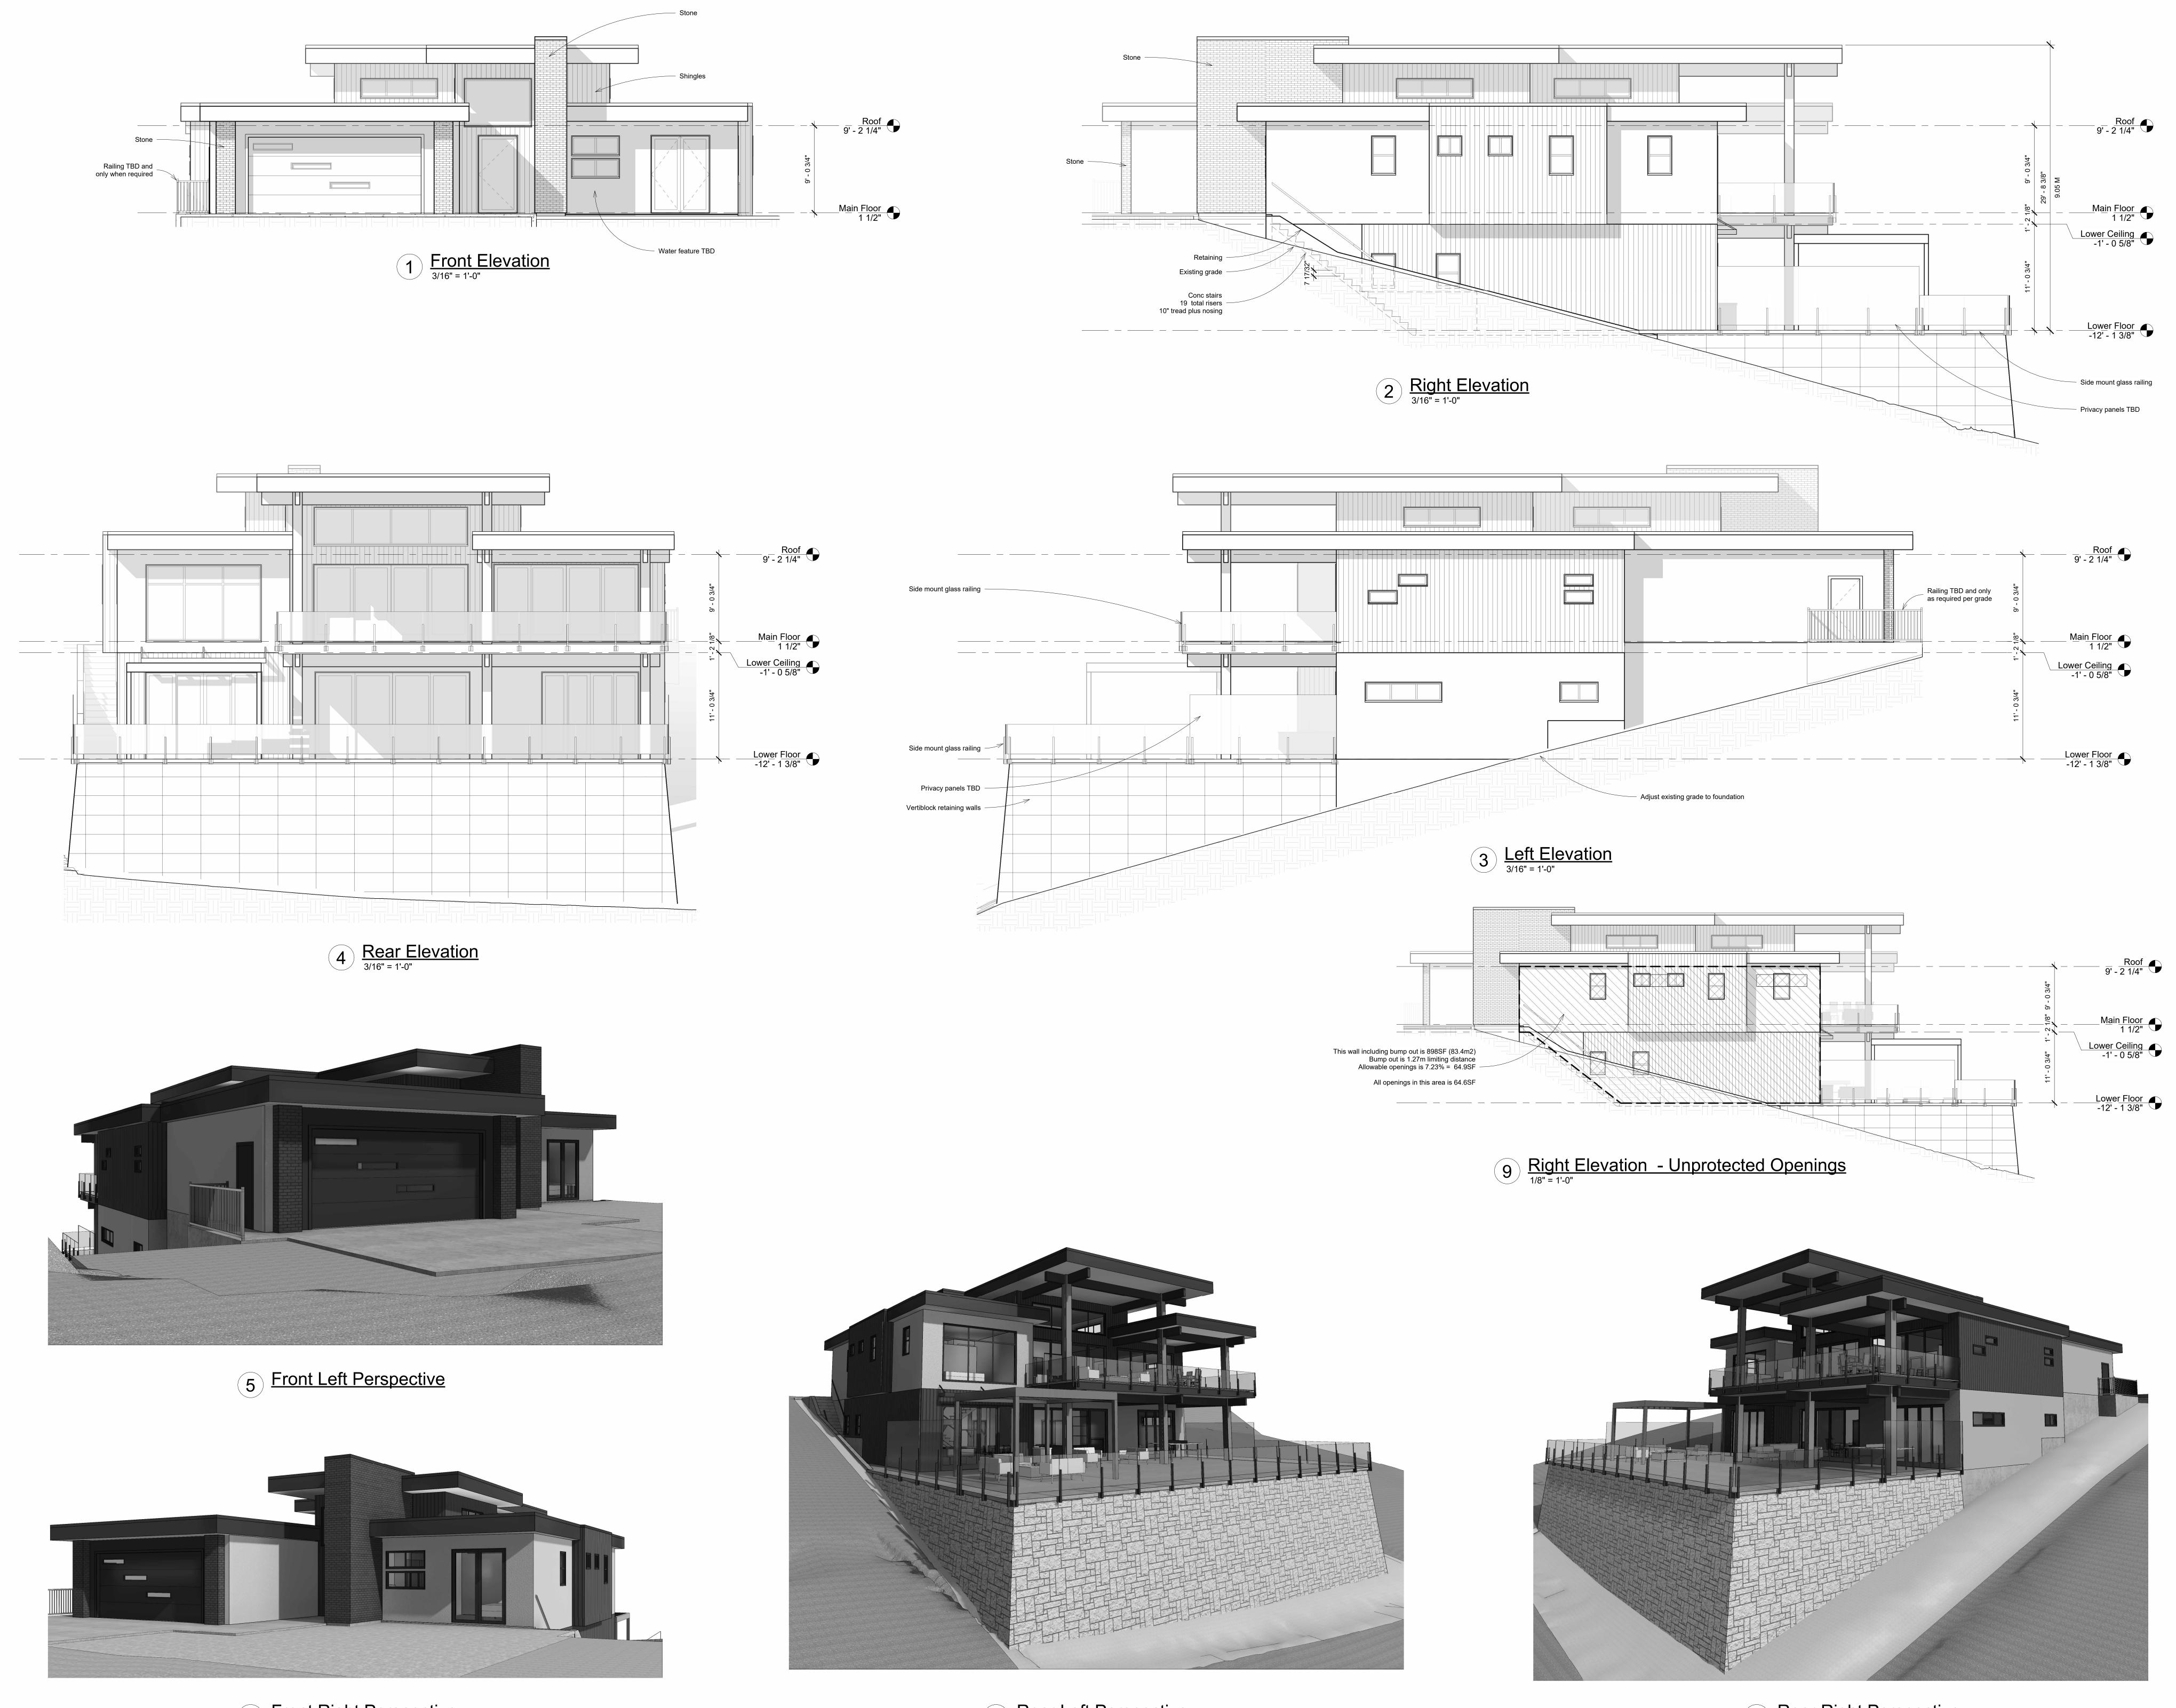

6 Front Right Perspective



7 Rear Left Perspective

8 Rear Right Perspective



<u>Vertical siding</u> Vertical 6" t+g siding Minimal trim on windows and door

No or miniumal corners

<u>Brick Veneer</u> Cultured or real brick installed per supplier Painted aluminum flashing over curb

<u>Fascia</u> Painted aluminum flashing over curb Smooth acrylic stucco

<u>Deck Edges and Posts</u> Clad deck edge painted smart trim Posts are smooth acrylic stucco

<u>Exposed Beams</u> Structural and faux beams are to be laminated timber. Stained.

Windows and Doors

All exterior door and window sizes, patterns, combinations, configurations and separations to be confirmed by window manufacturer to Ensure NAFS (North American Fenestration Standard) compliance. What is shown on the plans is a representation of the look and feel intended by the designer. The type of window used and manufacturer specs may vary and therefore need to be confirmed prior

to construction.

MEYER DESIGNS LTD

600 Mt Tod Drive Coldstream, BC V1B 3Y6 250-503-4579 Kelly@MeyerDesigns.ca MeyerDesigns.ca

Elevations and Perspectives

2022-031

April 24, 2024


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Kelly Meyer

Project number Date Drawn by

LeClair Residence 1121 - 19th Ave Salmon Arm, BC

For Permit v2.1

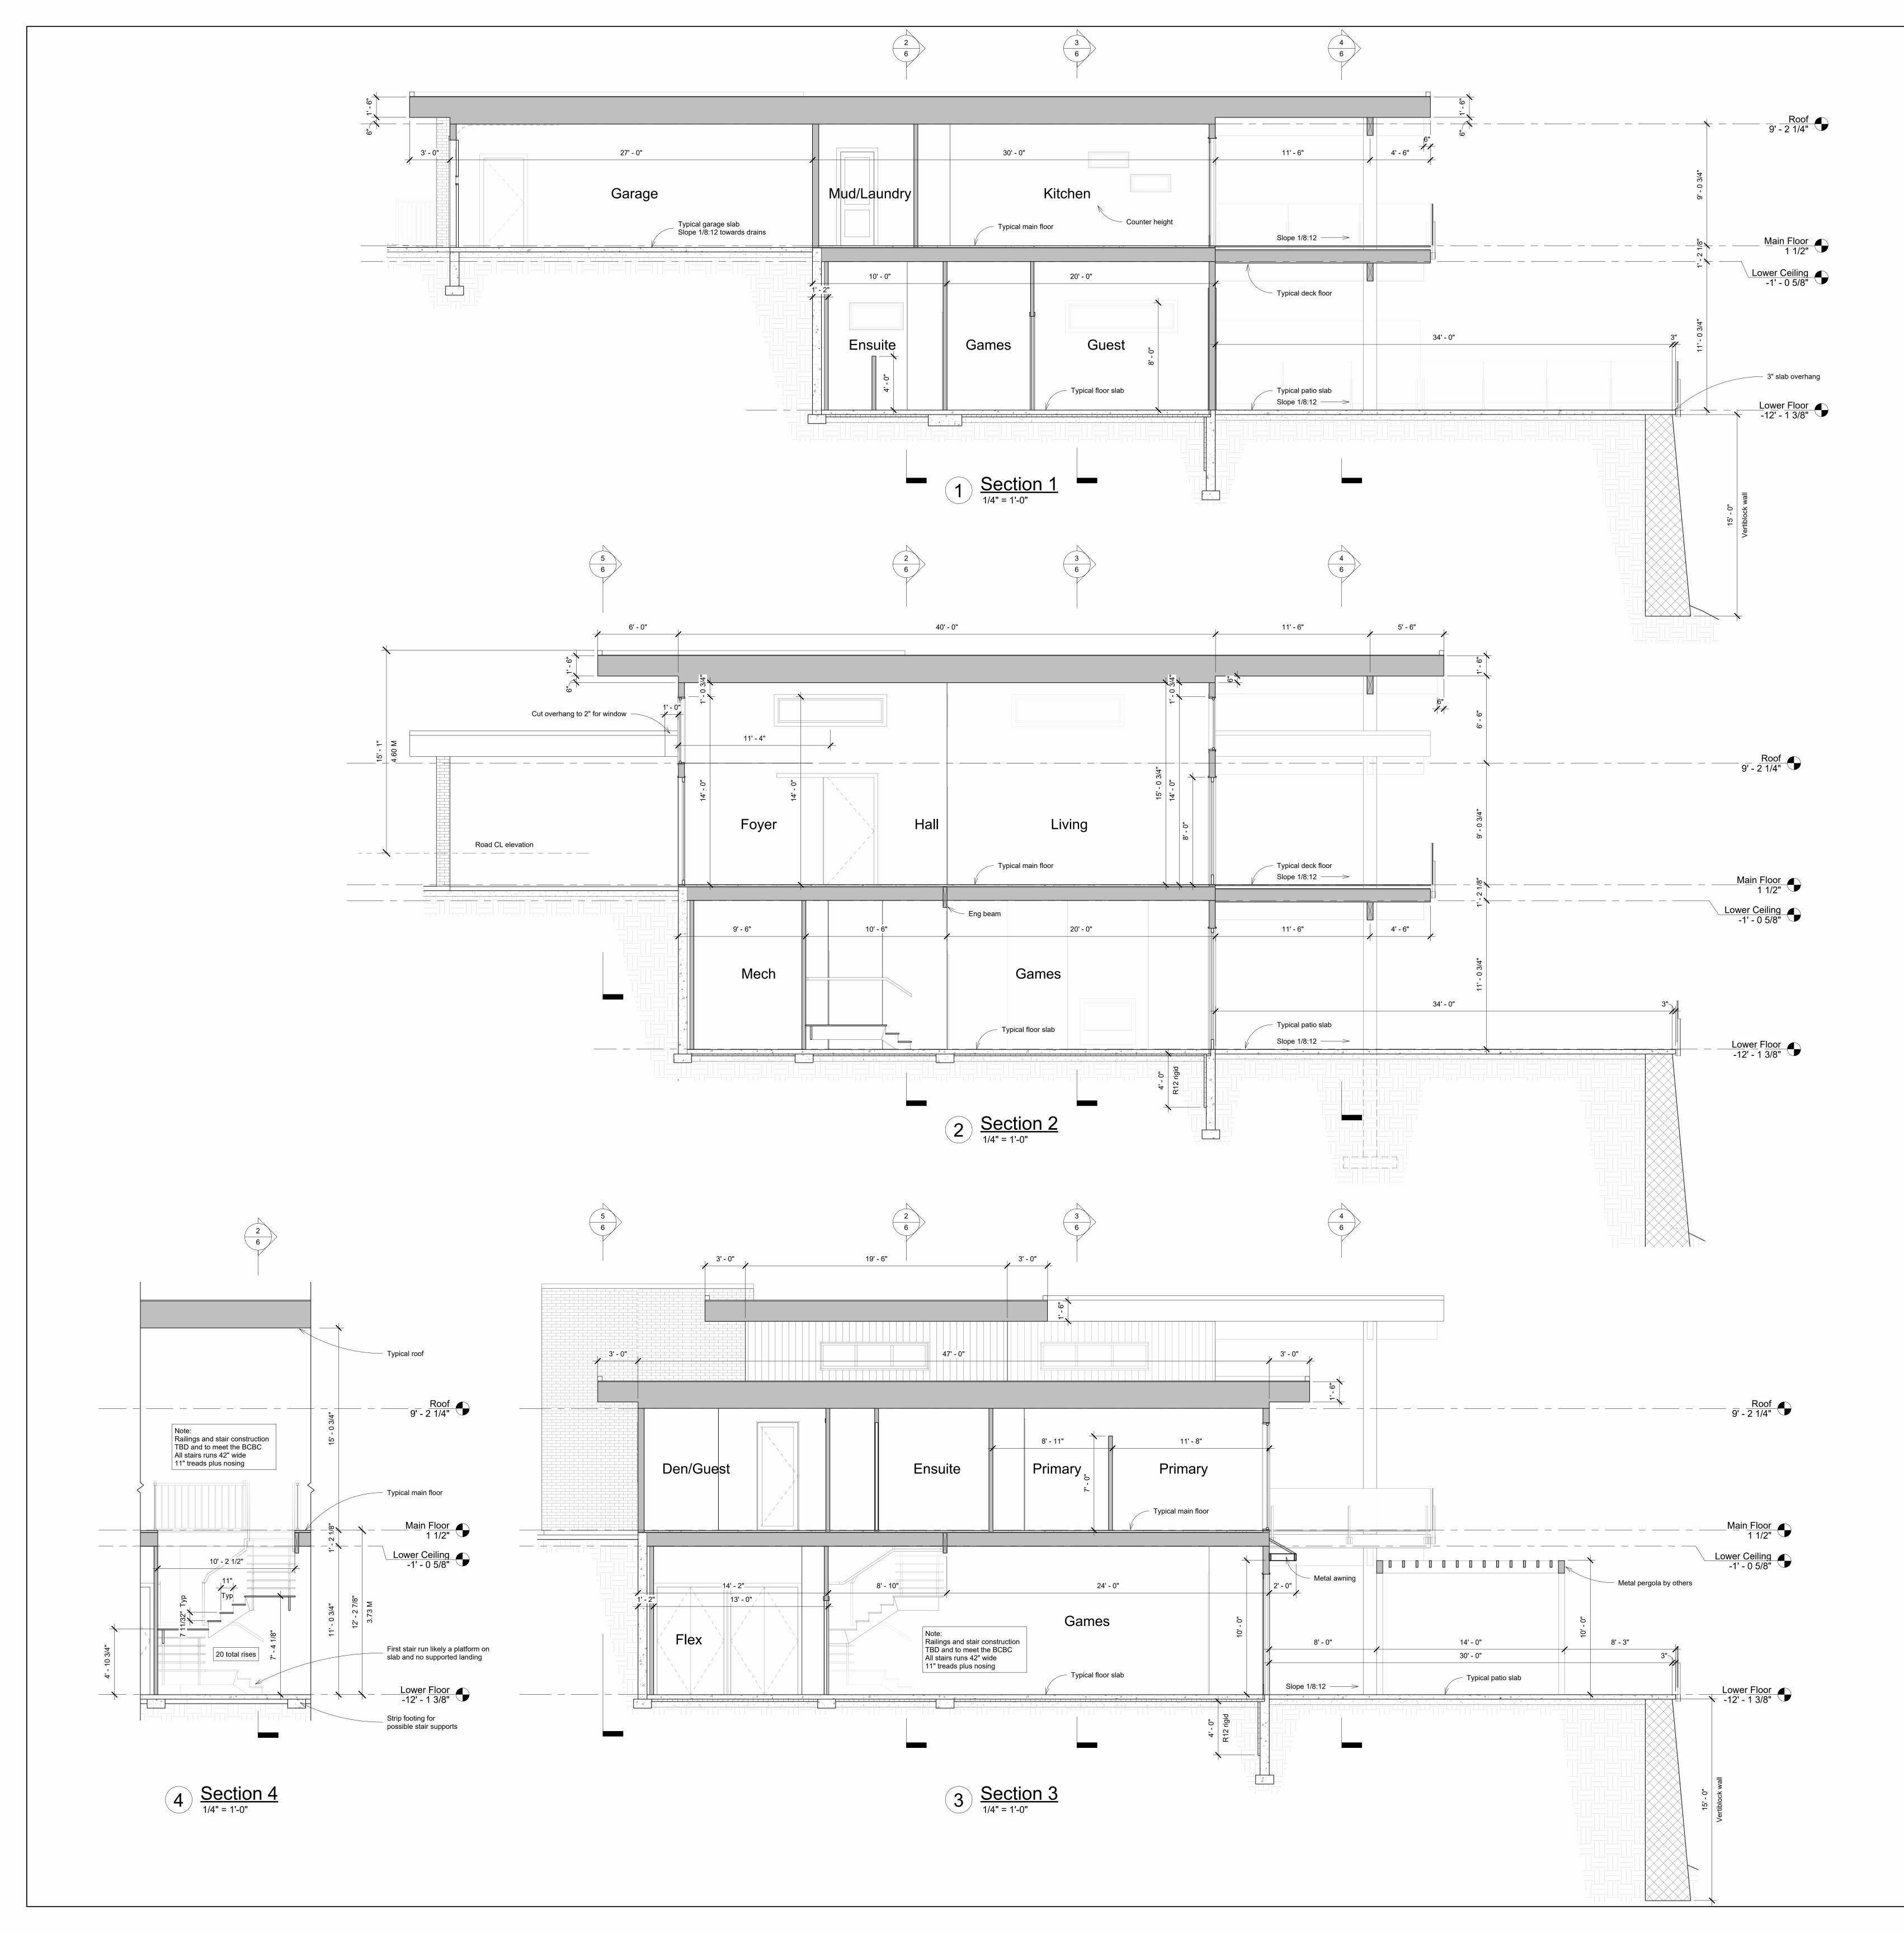

Typical Walls

Foundation wall Conc foundation per engineering Min 8" walls on 16"x8" footing at minimum frost cover Damproofing to intended grade line Drain tile with silt screen around perimeter Rigid (R12) insulation on inside of frost walls (4'-0")

<u>Exterior wall</u> Stucco or stone finish On building paper or wrap 1/2" plywood 2x6 stud wall @ 24" oc R24 batt insulation 6 mil poly 1/2" drywall

<u>Interior wall</u> 2x4 stud wall @ 16"oc 1/2" drywall both sides

Below grade insulation wall 8" conc wall with dampproofing 2" air space 2x4 stud wall @ 16"oc (aligned 6" from conc) R20 batt insulation (1" into airspace) 6 mil poly 1/2" drywall

<u>Retaining</u> Vertiblock and Retaining walls designed by others

Typical Floors

Main Floor (Heated and over heated space) 1.5" conc 3/4" t&g plywood 11 7/8" eng joists per supplier 5/8" drywall

<u>Boxed joist ends</u> 1" rim board

R28 spray insulation

Floor slab (heated)
4" finished concrete Wire mesh reinforcing

1.5" thermal break to foundation R12 rigid insulation under entire slab heated portion 6 mil poly 5" compacted granular fill

Provide ground venting for radon gas Garage floor slab 4" finished concrete Slope garage slabs towards door at 1/8:12

10M bars 24" oc BW 6 mil poly 5" compacted granular fill

Patio slab 4" finished concrete 10M bars 24" oc BW 6 mil poly 5" compacted granular fill

Slope 1/8:12 away from house Pool deck portion of patio to be confirm for structure **Deck floor** Floating tile decking flush with inside finished floor Torth on waterproofing

3/4" t+g plywood 2x12 joists 16"oc c/w blocking Vented soffit TBD Slope 1/8:12 away from house

Typical Roof

<u>Flat Roof</u> 2 layers torch-on roofing

7/16" plywood Eng roof trusses @ 24"oc 24" deep over heated area 1/4" slope for drainage as shown


18" deep overhangs 4" curb c/w metal flashing


Provide roof drains and downspouts R50 insulation at the ceiling over heated spaces


6 mil poly 5/8" drywall over heated spaces


No attic to vent Vented soffits under overhangs (TBD)




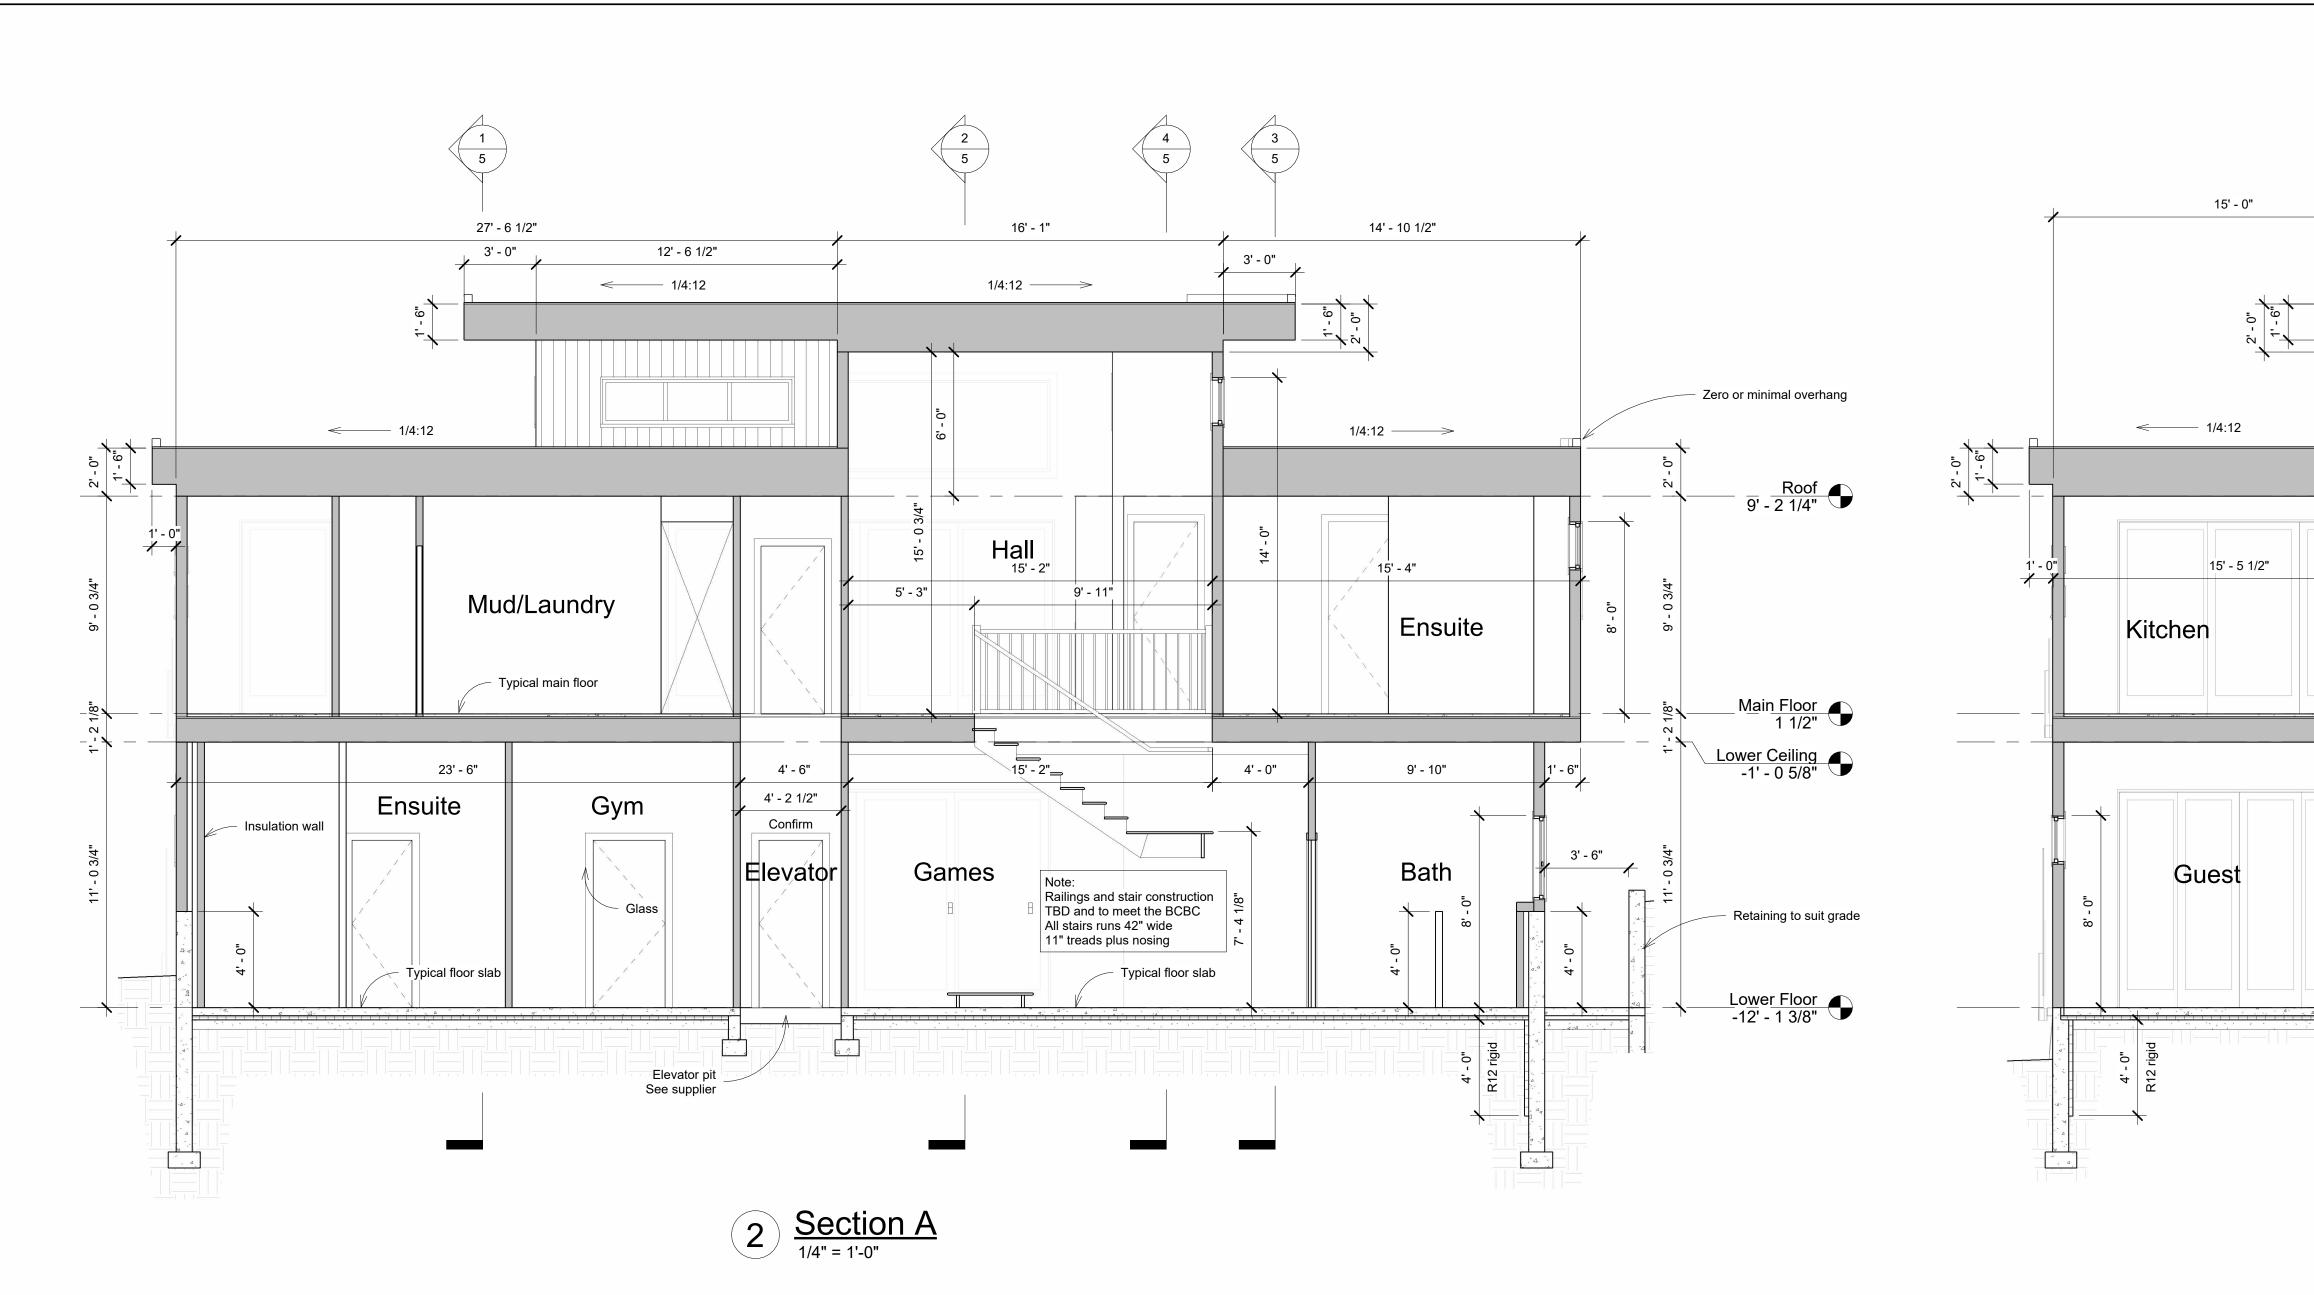

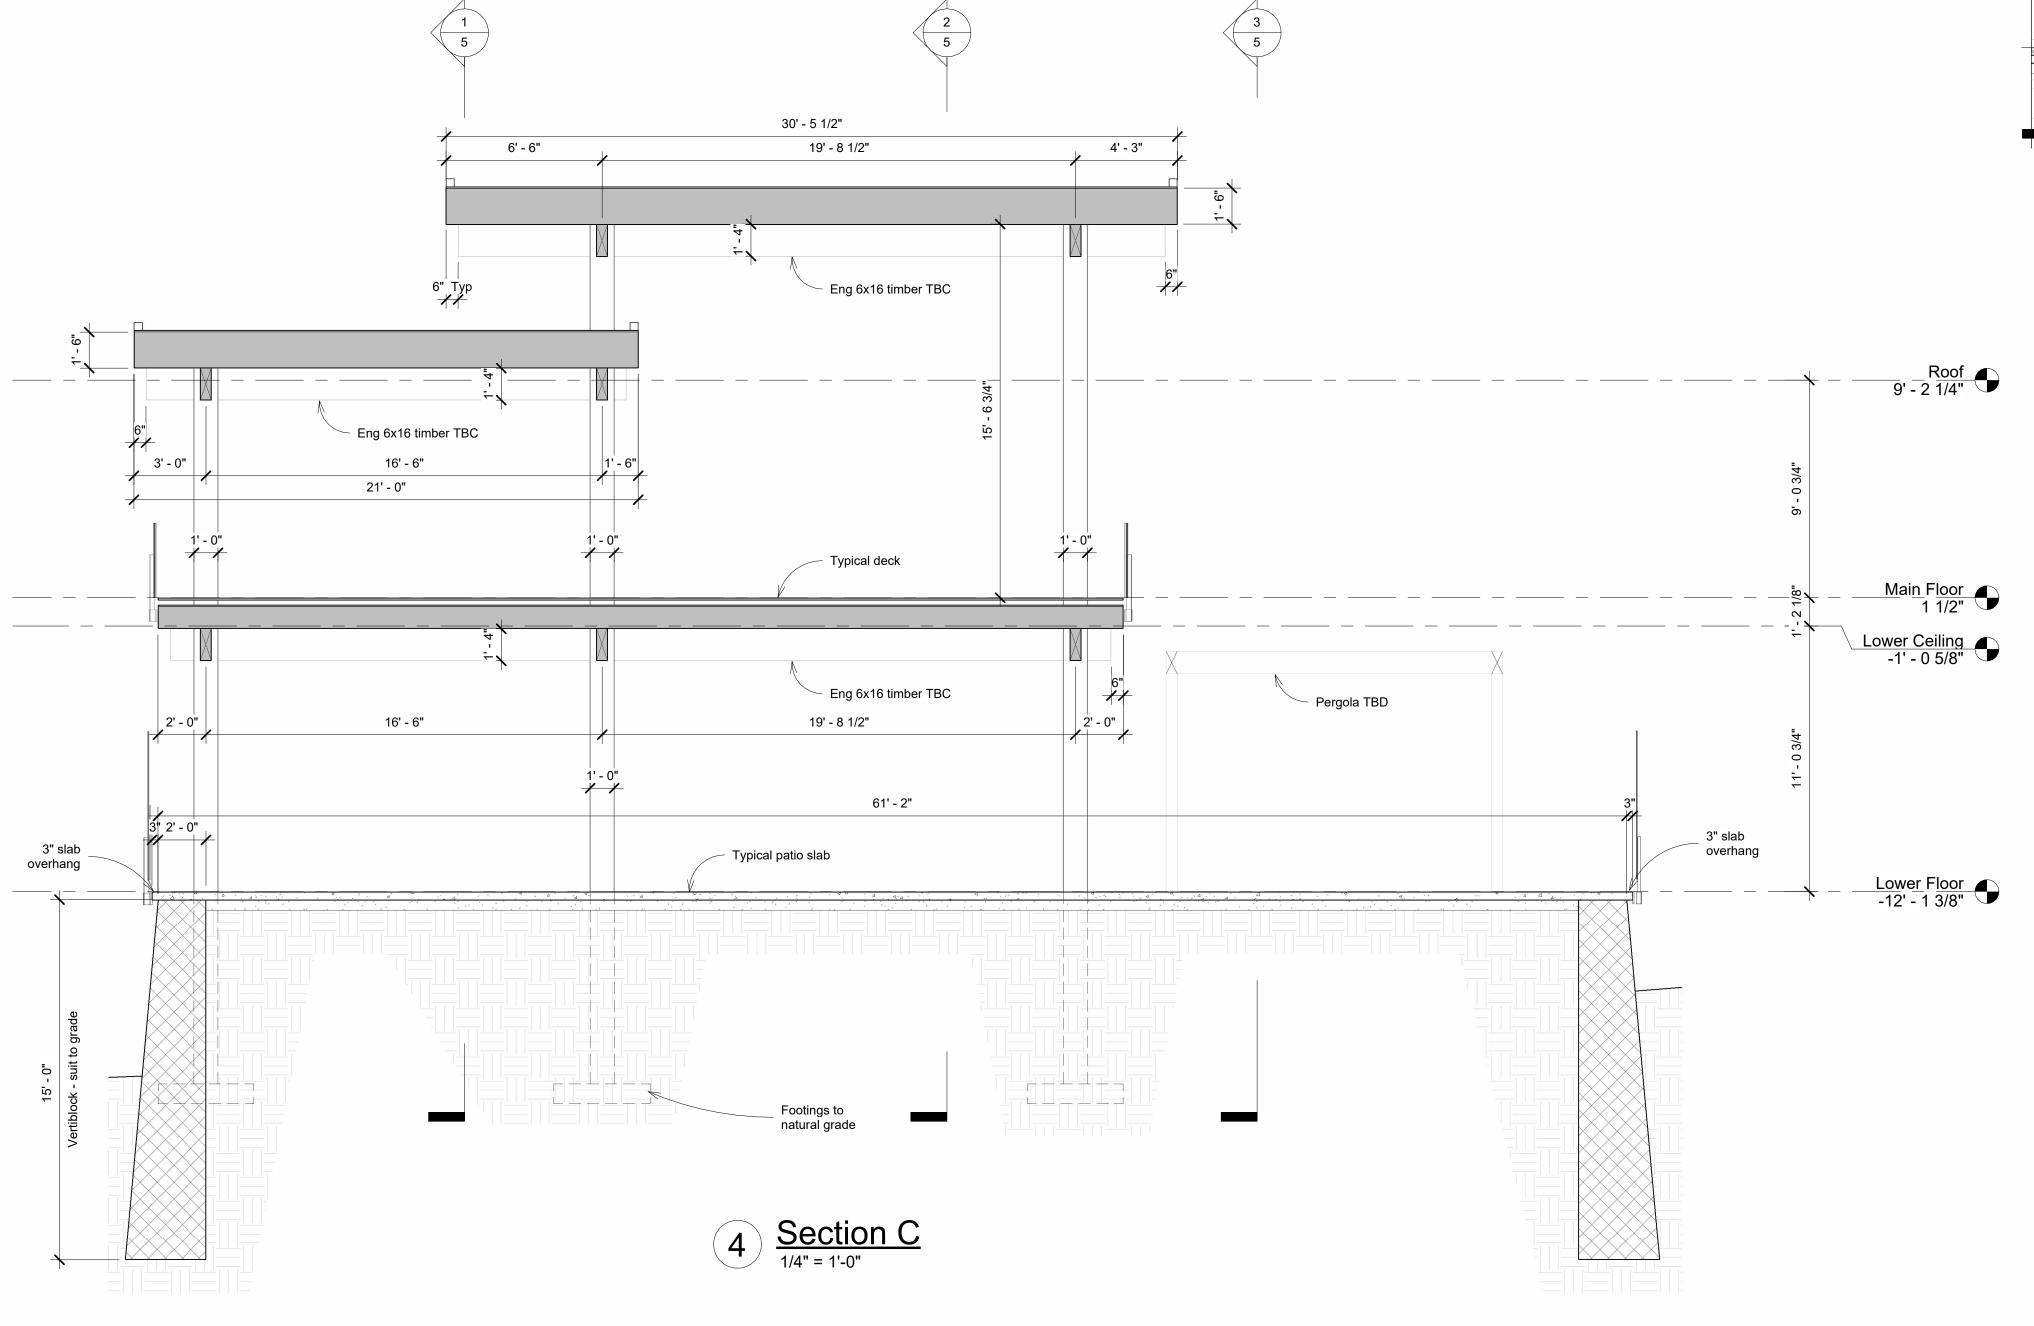

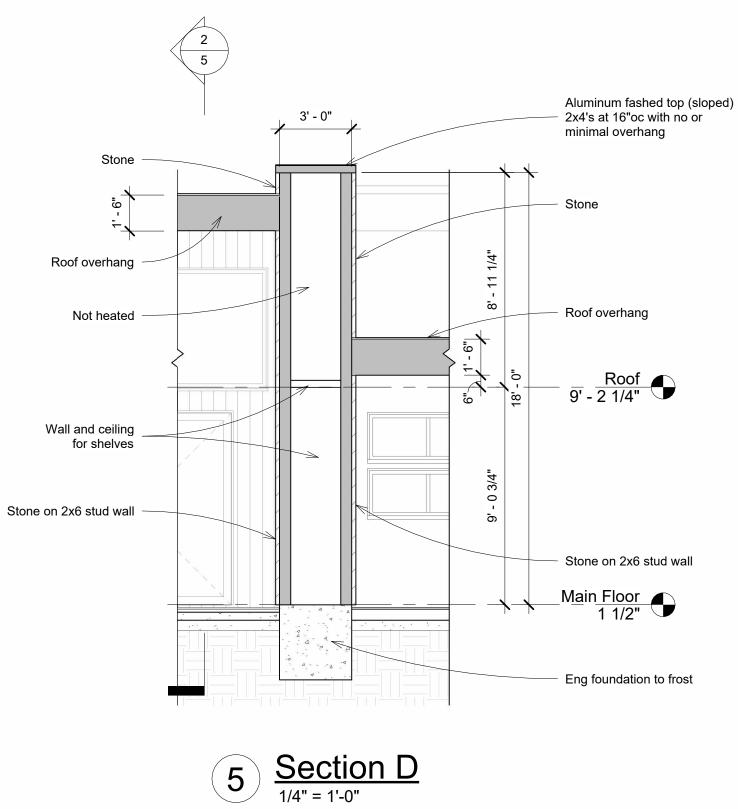

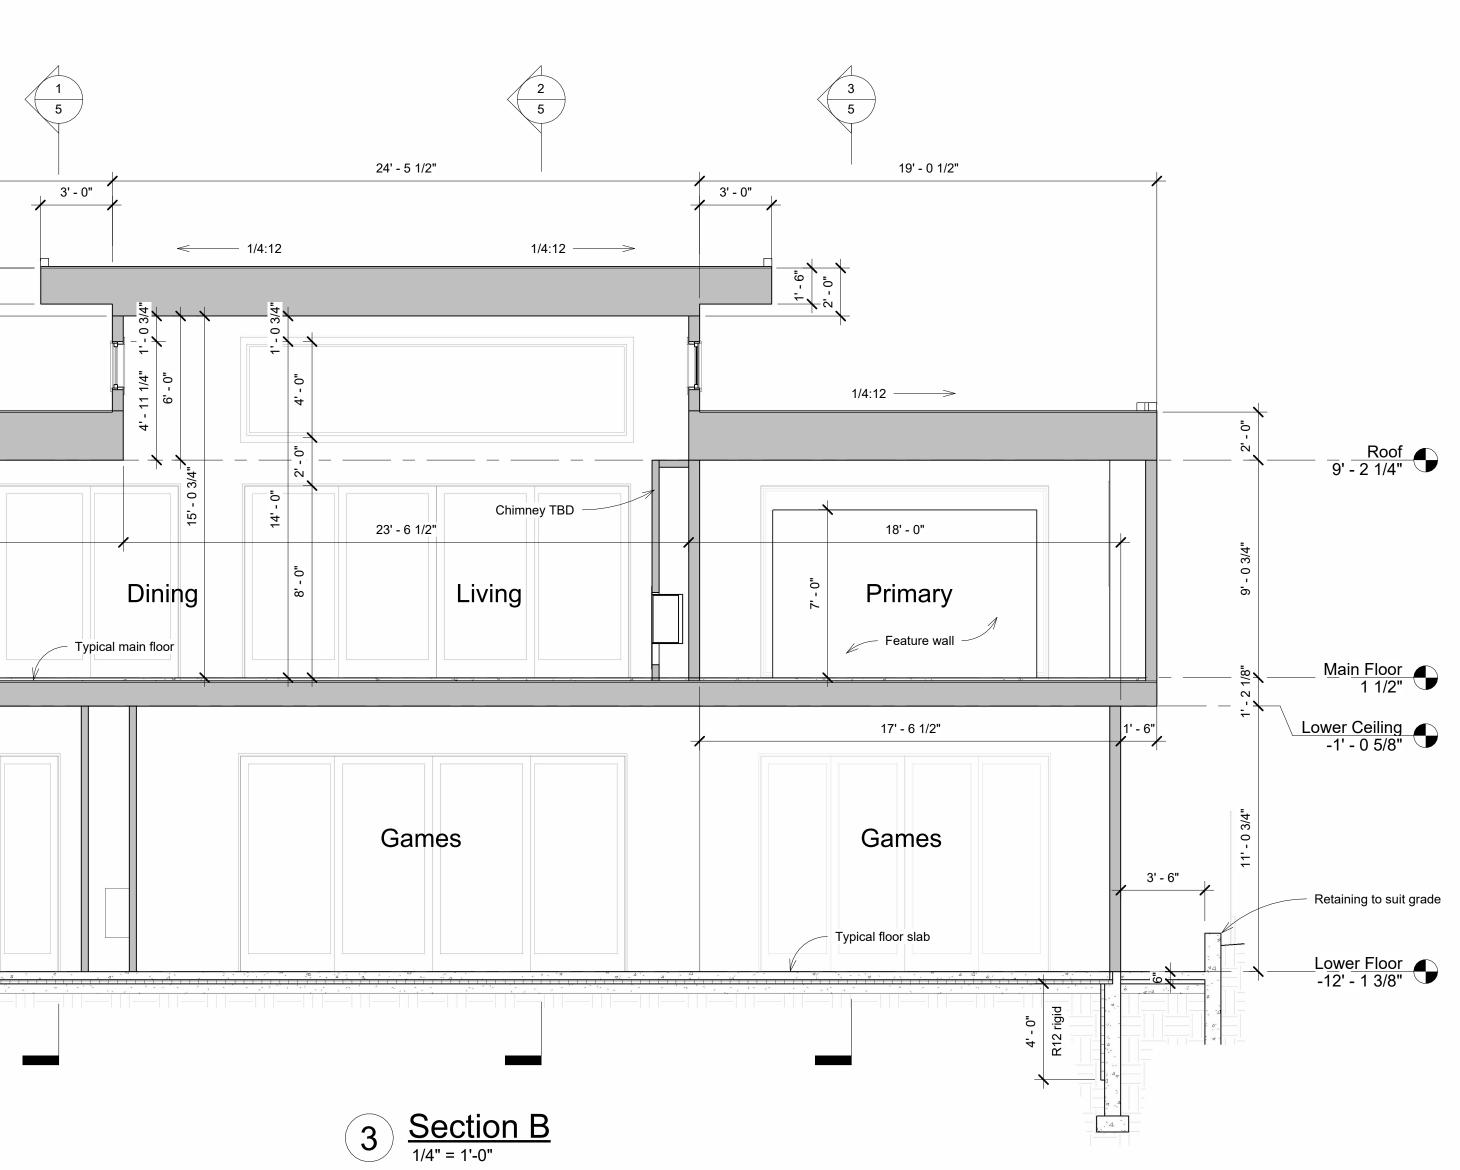

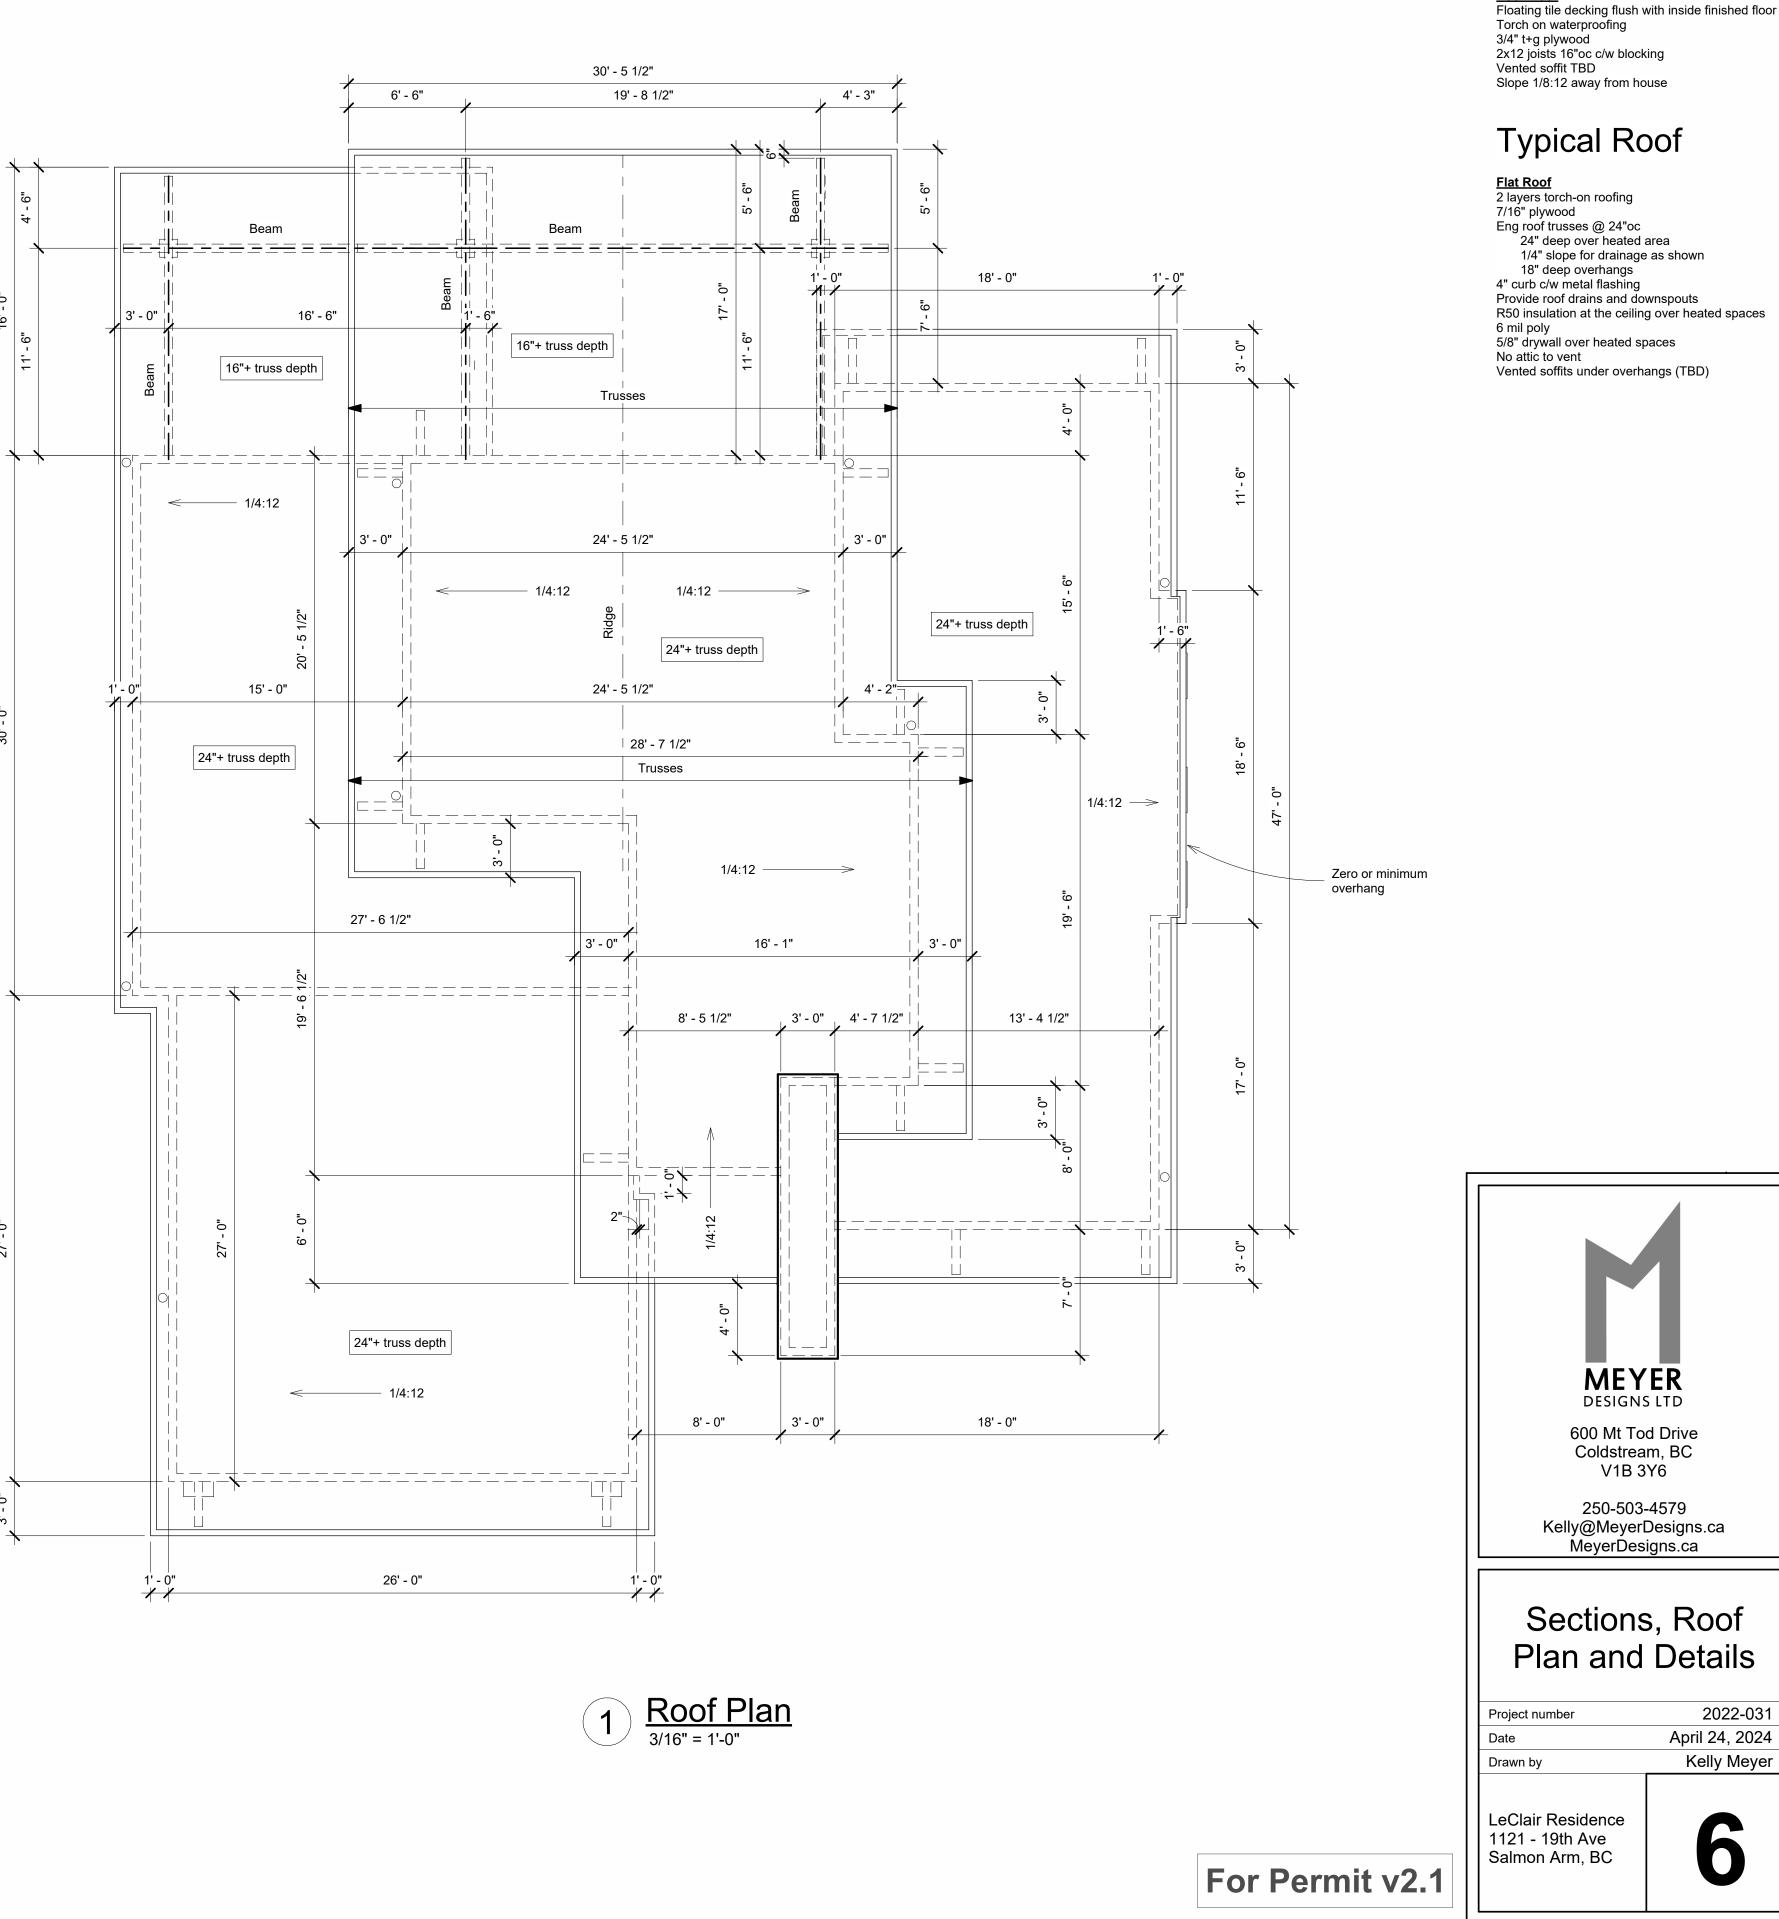

Typical Walls

Foundation wall Conc foundation per engineering Min 8" walls on 16"x8" footing at minimum frost cover Damproofing to intended grade line Drain tile with silt screen around perimeter Rigid (R12) insulation on inside of frost walls (4'-0") Exterior wall Stucco or stone finish On building paper or wrap 1/2" plywood

2x6 stud wall @ 24" oc R24 batt insulation 6 mil poly 1/2" drywall Interior wall 2x4 stud wall @ 16"oc

1/2" drywall both sides Below grade insulation wall 8" conc wall with dampproofing

2" air space 2x4 stud wall @ 16"oc (aligned 6" from conc) R20 batt insulation (1" into airspace) 6 mil poly 1/2" drywall

<u>Retaining</u> Vertiblock and Retaining walls designed by others

Typical Floors

<u>Main Floor</u> (Heated over heated space) 1.5" conc 3/4" t&g plywood 11 7/8" eng joists per supplier 5/8" drywall

<u>Boxed joist ends</u> 1" rim board

R28 spray insulation Floor slab (heated) 4" finished concrete

Wire mesh reinforcing 1.5" thermal break to foundation R12 rigid insulation under entire slab heated portion

6 mil poly 5" compacted granular fill Provide ground venting for radon gas

<u>Garage floor slab</u> 4" finished concrete Slope garage slabs towards door at 1/8:12 10M bars 24" oc BW 6 mil poly 5" compacted granular fill

Patio slab 4" finished concrete 10M bars 24" oc BW 6 mil poly 5" compacted granular fill Slope 1/8:12 away from house Pool deck portion of patio to be confirm for structure

Deck floor Floating tile decking flush with inside finished floor Torch on waterproofing 3/4" t+g plywood 2x12 joists 16"oc c/w blocking

Vented soffits under overhangs (TBD)